

NOTE: 3D RENDERS FOR REFERENCE ONLY. FINAL COLOURS MAY VARY BASED ON SPECIFICATION, MONITOR COLOUR SETTINGS, AND/OR PRINT QUALITY. DO NOT SCALE.

GENERAL SITE INF	<u>-O:</u>	AMENITY SPACE:	
SEC. 14	F LOT A, PLAN KAP56202 & 15, TP. 23, ODYD A CENTRALE	UNIT 1 (TOTAL): FRONT DECK: 16.82 m <sup>2</sup>	35.40 m²
	- KELOWNA	REAR PATIO: 18.58 m <sup>2</sup> UNIT 2 (TOTAL): FRONT DECK: 16.63 m <sup>2</sup>	33.35 m²
SITE COVERAGE:		REAR PATIO: 16.72 m <sup>2</sup> UNIT 3 (TOTAL): FRONT DECK: 16.63 m <sup>2</sup>	33.35 m²
SITE AREA: (PROPOSED LOT LINES)	<u>1607.55 m²</u>	REAR PATIO: 16.72 m <sup>2</sup> UNIT 4 (TOTAL): FRONT DECK: 16.82 m <sup>2</sup> REAR PATIO: 18.58 m <sup>2</sup>	35.40 m²
PROVIDED COVERAGE:		UNIT 5 (TOTAL): FRONT DECK: 11.52 m <sup>2</sup> REAR PATIO: 18.58 m <sup>2</sup>	30.10 m²
BUILDING 1 FOOTPRINT: DRIVEWAY PARKING AREA:	311.41 m² 95.39 m²	UNIT 6 (TOTAL): FRONT DECK: 10.31 m <sup>2</sup> REAR PATIO: 16.72 m <sup>2</sup>	27.03 m²
DECKS & PATIO ABOVE 0.6m: BUILD-OUTS:	35.30 m² 0.59 m²	UNIT 7 (TOTAL): FRONT DECK: 24.81 m <sup>2</sup> REAR PATIO: 16.94 m <sup>2</sup>	41.75 m²
BUILDING 2 FOOTPRINT: DRIVEWAY PARKING AREA: DECKS & PATIO ABOVE 0.6m: BUILD-OUTS:	243.43 m² 82.62 m² 16.94 m² 0.97 m²	TOTAL AMENITY SPACE:	<u>236.38 m²</u>
VISITOR PARKING AREA:	18.04 m²	BUILDING HEIGHT	·.
TOTAL COVERAGE ON SITE: COVERAGE:	804.69 m² <u>50.06 %</u>	DOILDING HEIGHT	<u>.</u>
DENSITY:		BUILDING 1 AVERAGE GRADE (4 CORNEI ROOF PEAK: ROOF EAVE: ROOF AVERAGE HIGH POINT <u>BUILDING HEIGHT:</u>	512.19 510.40
SITE AREA: <u>0.1607 ha</u> UNITS: 7 DENSITY: 43.56 units / ha		Building 2 Average grade (4 corne) Roof Peak: Roof Eave: Roof Average High Point	512.19 510.06 511.12
		BUILDING HEIGHT:	<u>8.97m</u>
		. ELLERGODT DESIGN TAKES NO REPSO VERIFY ALL CRITICAL DIMENSIONS ON S	

SHEET LIST	
SHEET NAME	PAGE #
BUILDING STATISTICS	A0.0
SITE PLAN	A0.1
MAIN FLOOR PLAN	A1.1
UPPER FLOOR PLAN	A1.2
3rd FLOOR PLAN	A1.3
ROOF PLAN	A1.4

ELEVATIONS	A2.0
ELEVATIONS	A2.1
ELEVATIONS	A2.2

# <u>THE POINTE AT QUAIL</u>

4- & 3-UNIT MULTI-FAMILY ATTACHED DWELLING 3179 VIA CENTRALE KELOWNA, BRITISH COLUMBIA PART OF LOT A, SEC. 14 AND 15, TP 23, ODYD, PLAN KAP56202

# **CARLISLE GROUP**

### AMENITY SPACE:

UNIT 1 (TOTAL):	35.40 m²
FRONT DECK: 16.82 m <sup>2</sup>	
REAR PATIO: 18.58 m <sup>2</sup>	
UNIT 2 (TOTAL):	33.35 m²
FRONT DECK: 16.63 m <sup>2</sup>	
REAR PATIO: 16.72 m <sup>2</sup>	
UNIT 3 (TOTAL):	33.35 m²
FRONT DECK: 16.63 m <sup>2</sup>	
REAR PATIO: 16 72 m <sup>2</sup>	
UNIT 4 (TOTAL):	35.40 m <sup>2</sup>
FRONT DECK: 16 82 m <sup>2</sup>	00.101
REAR PATIO: 18.58 m <sup>2</sup>	
UNIT 5 (TOTAL):	30 10 m <sup>2</sup>
FRONT DECK: 11.52 m <sup>2</sup>	00.10111
REAR PATIO: 18.58 m <sup>2</sup>	
UNIT 6 (TOTAL):	27 03 m <sup>2</sup>
FRONT DECK: 10.31 m <sup>2</sup>	27.00 m
REAR PATIO: 16.72 m <sup>2</sup>	
UNIT 7 (TOTAL):	41.75 m <sup>2</sup>
FRONT DECK: 24.81 m <sup>2</sup>	41.7011
REAR PATIO: 16.94 m <sup>2</sup>	
REARTANO: 10.34 III	
TOTAL AMENITY SPACE:	236.38 m <sup>2</sup>
TOTAL AMENITY OF AGE.	<u>200.00 m</u>

### BUILDING HEIGHT:

BUILDING 1	
AVERAGE GRADE (4 CORNERS):	502.12
ROOF PEAK:	512.19
ROOF EAVE:	510.40
ROOF AVERAGE HIGH POINT:	511.30
BUILDING HEIGHT:	<u>9.18m</u>
BUILDING 2 AVERAGE GRADE (4 CORNERS): ROOF PEAK: ROOF EAVE: ROOF AVERAGE HIGH POINT: <u>BUILDING HEIGHT:</u>	502.15 512.19 510.06 511.12 <u>8.97m</u>


 UNIT STATISTICS:	
BUILDING 1 (TOTAL DEVELOPED):	6,002 SF
UNIT 1 (3-BED) UNIT 2 (2-BED) UNIT 3 (2-BED) UNIT 4 (3-BED)	1,592 SF 1,409 SF 1,409 SF 1,592 SF
BUILDING 2 (TOTAL DEVELOPED):	<u>5,137 SF</u>
UNIT 5 (3-BED) UNIT 6 (2-BED) UNIT 7 (3-BED)	1,583 SF 1,400 SF 2,154 SF
OVERALL FRONT DECKS: OVERALL REAR DECKS: OVERALL GARAGES:	1,232 SF 1,364 SF 4,189 SF
<u>GROSS FLOOR AREA (DEVELOPED):</u> GFA	<u>11,139 SF</u> 1,034.85 m²
FAR:	
SITE AREA: GROSS FLOOR AREA (ALL LEVELS):	1607.55 m² 1034.85 m²
FAR:	<u>0.644</u>
PARKING:	
UNITS: TOTAL PARKING STALLS PROVIDED:	7 <u>14</u>
UNIT 1: 2.0 INDOOR TANDEM STALLS	2
UNIT 2: 2.0 INDOOR TANDEM STALLS	2
UNIT 3: 2.0 INDOOR TANDEM STALLS	2
UNIT 4: 2.0 INDOOR TANDEM STALLS	2
UNIT 5: 2.0 INDOOR TANDEM STALLS	2
UNIT 6: 2.0 INDOOR TANDEM STALLS	2
UNIT 7: 1.0 INDOOR TANDEM STALLS	1

1.0 VISITOR OUTDOOR PARKING STALL 1

BUILDING	GAREAS	
NAME	SQUARE FOOTAGE	1
UNIT 1- MAIN	136 SF	UNIT 5- M
UNIT 1- UPPER	720 SF	UNIT 5- U
UNIT 1- 3rd	736 SF	UNIT 5- 3r
UNIT 1- GARAGE	656 SF	UNIT 5- G
UNIT 1- FRONT DECK	181 SF	UNIT 5- FF
UNIT 1- REAR DECK	200 SF	UNIT 5- R
UNIT 2- MAIN	132 SF	UNIT 6- M
UNIT 2- UPPER	648 SF	UNIT 6- U
UNIT 2- 3rd	629 SF	UNIT 6- 3r
UNIT 2- GARAGE	598 SF	UNIT 6- G
UNIT 2- FRONT DECK	179 SF	UNIT 6- FF
UNIT 2- REAR DECK	180 SF	UNIT 6- R
UNIT 3- MAIN	132 SF	UNIT 7- M
UNIT 3- UPPER	648 SF	UNIT 7- U
UNIT 3- 3rd	629 SF	UNIT 7- 3r
UNIT 3- GARAGE	598 SF	UNIT 7- G
UNIT 3- FRONT DECK	179 SF	UNIT 7- FF
UNIT 3- REAR PATIO	180 SF	UNIT 7 - R
		7
UNIT 4- MAIN	136 SF	
UNIT 4- UPPER	720 SF	
UNIT 4- 3rd	736 SF	
UNIT 4- GARAGE	657 SF	
UNIT 4- FRONT DECK	181 SF	
UNIT 4- REAR PATIO	200 SF	

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CLIENT &	PROJECT CARLISLE GROUP	
PROJECT:	THE POINTE AT QUAIL	
ADDRESS:		
LEGAL:	LOT A, PLAN KA56202	
JOB NO. :	-	
DRAV	VING	
STAGE:	DEVELOPMENT PERMIT	
PUBLISHED:	2023-05-05 12:06:52 PM	
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11.10         MINOR REV.           12.09         PRELIM DP REVIEW           01.05         DP REVIEW           03.23         UNIT 2/3 - 18' OPTIOI	RC RC RC	
05.06 REV'D DP 06.15 PRELIMINARY PRICI 11.23 REV'D LOT LINES SI 03.27 DEVELOPMENT PER 05.05 DP ADJUSTMENTS	NG SL TE PLAN RC	

BUILDING	-
NAME	SQUARE FOOTAGE
MAIN	127 SF
UPPER	720 SF
3rd	736 SF
GARAGE	572 SF
FRONT DECK	124 SF
REAR PATIO	200 SF
MAIN	123 SF
UPPER	648 SF
3rd	629 SF
GARAGE	524 SF
FRONT DECK	111 SF
REAR PATIO	180 SF
MAIN	436 SF
UPPER	856 SF
3rd	862 SF
GARAGE	535 SF
FRONT DECK	267 SF
- REAR PATIO	182 SF

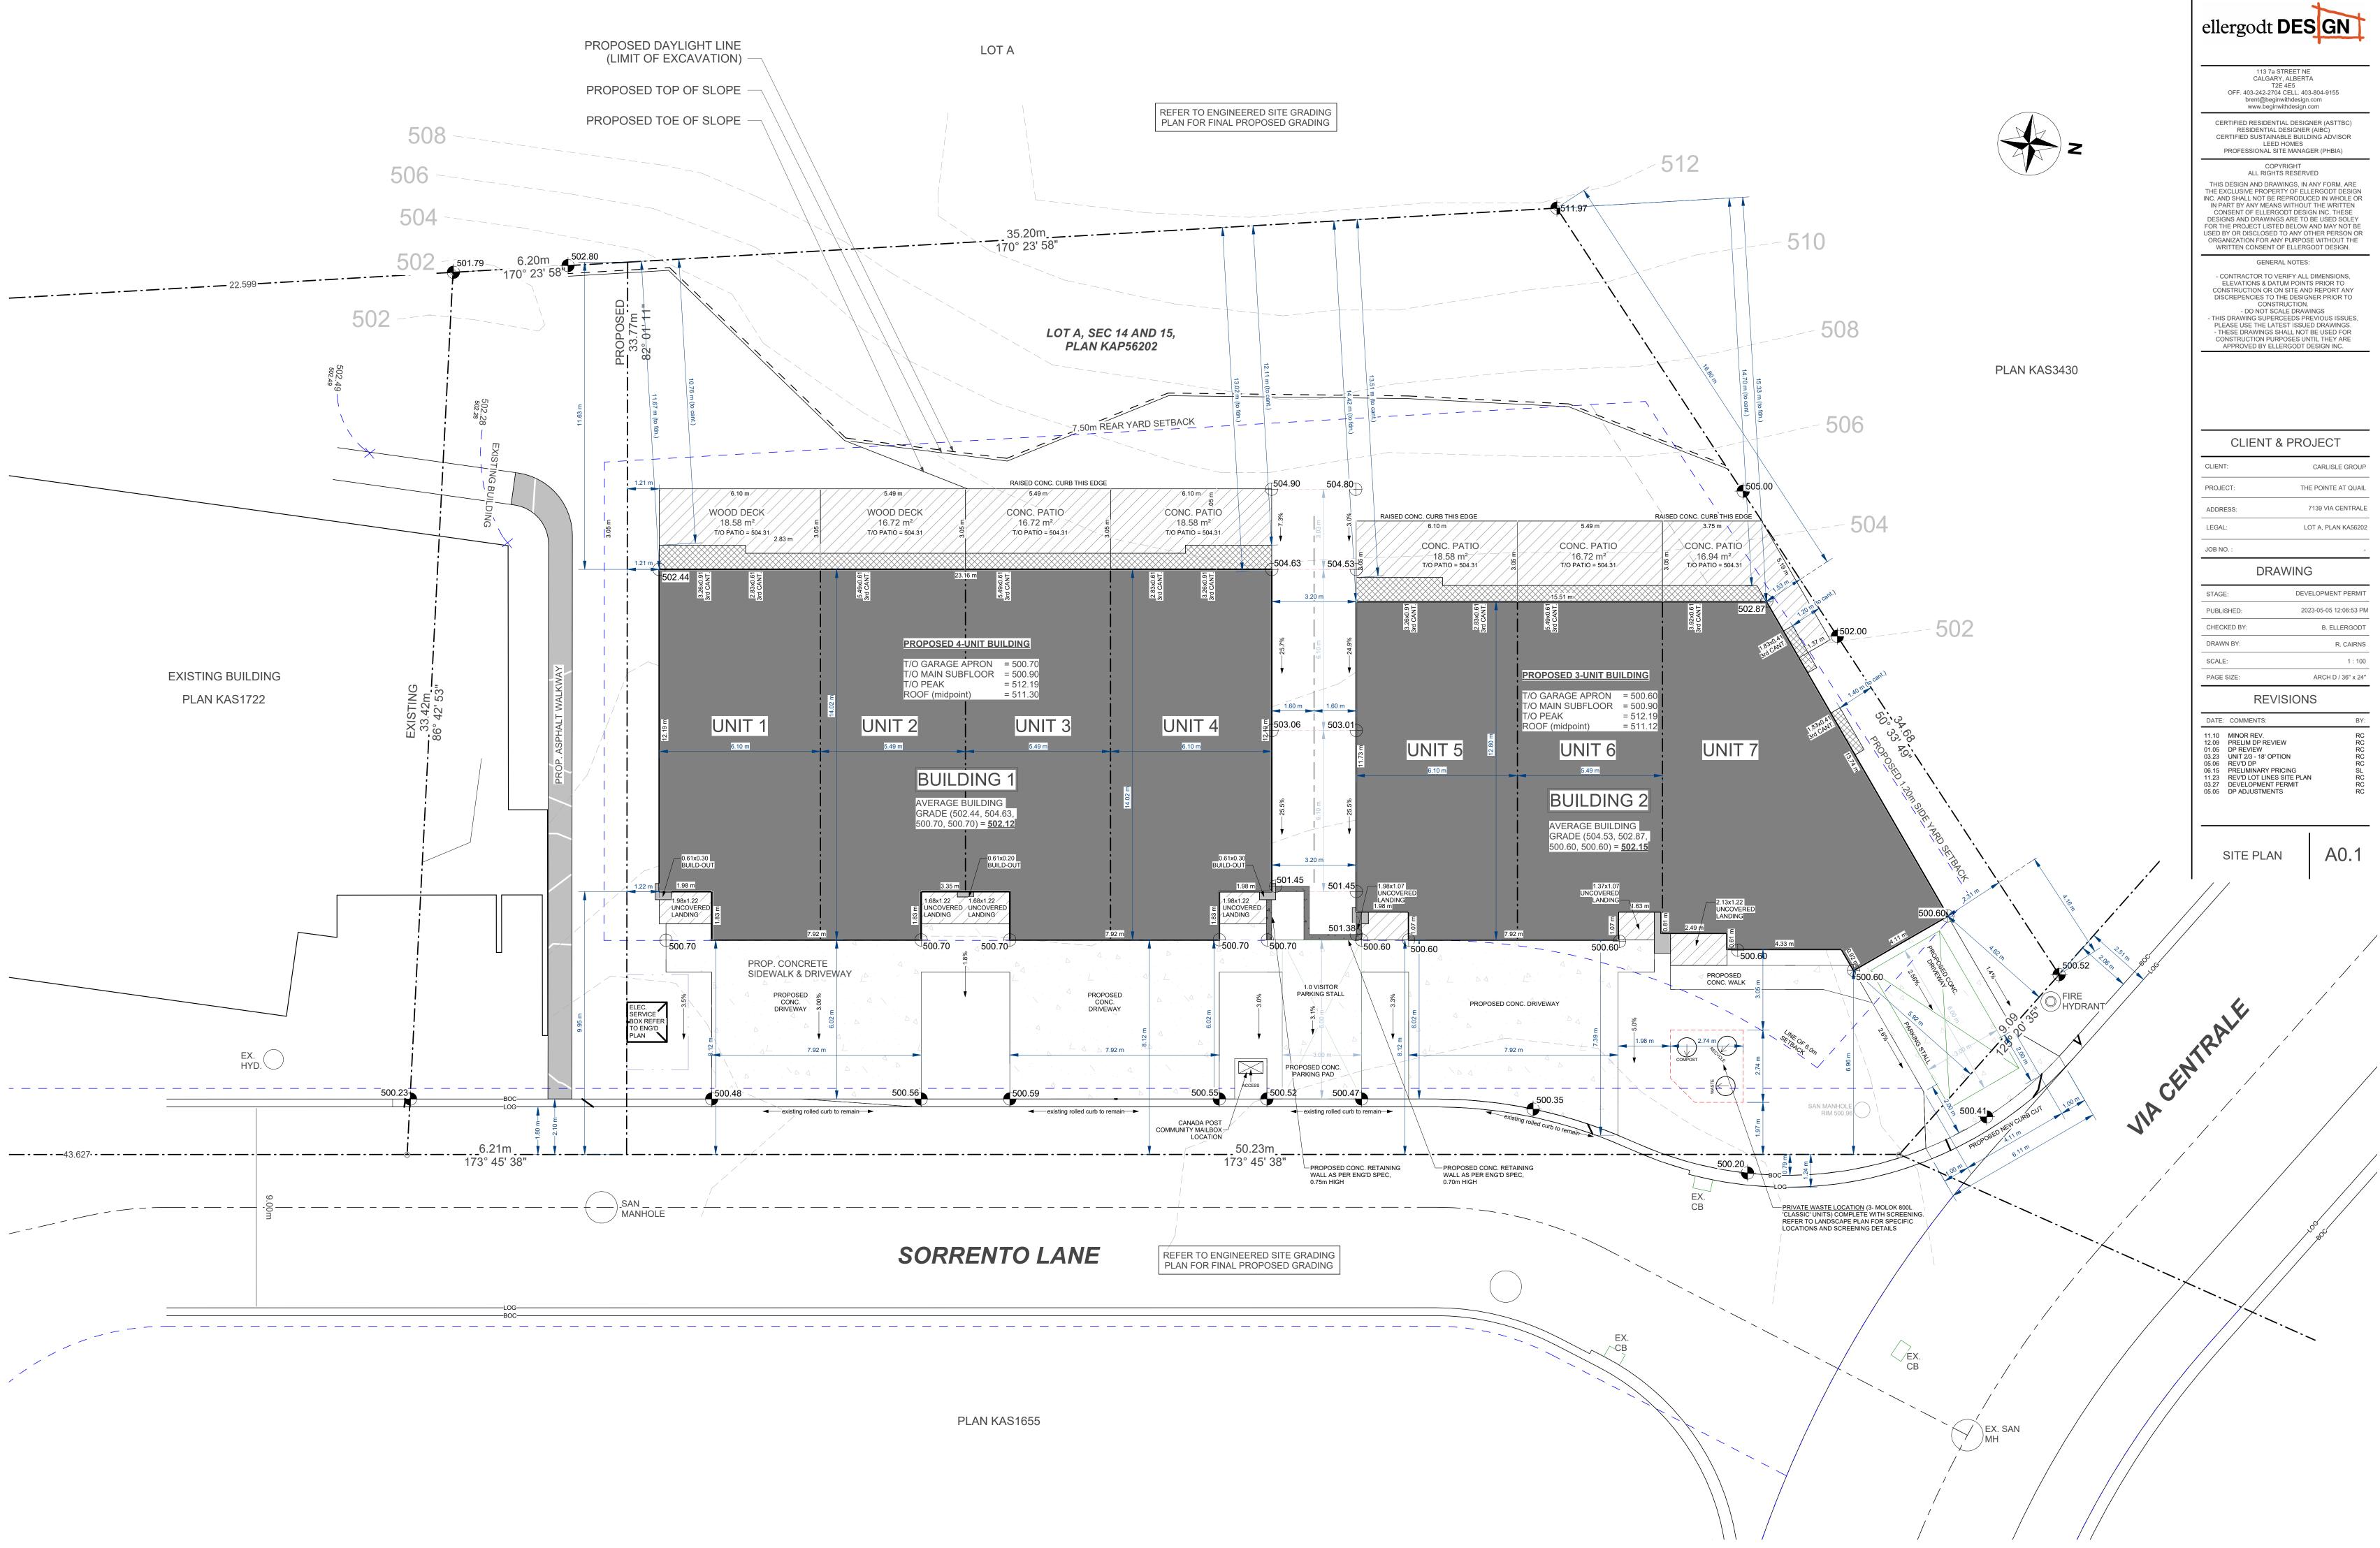



-1 PROPOSED MAIN FLOOR PLAN 3/16" = 1'-0"

MECH.

6' - 0"

4' - 8" 1' - 8"

\_ \_ \_ -

\_ \_ \_

- - - -

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- - - -

\_\_\_\_\_\_ IP 18RS \_\_\_\_

6' - 6"

3' - 6" 3' - 0" 6' - 10"

 $\mathbf{X}$ 

0' - 6"

WH

 $\mathbf{X}$ 

20' - 0"

GARAGE

CENTRE DRAIN

10'-3 1/4" CLEAR MAIN FLOOR CEILING
CEILINGS DROPPED FOR STRUCTURE OR MECH WHERE REQUIRED
TOPS OF WINDOWS @ 8'-0" UNO
ENG. HEADER FOR OPENINGS WIDER THAN 5'

6' - 2"

UNIT 2

12' - 6"

6' - 8"

UNIT 1

20' - 0"

13' - 6"

76' - 0"

MECH.

5' - 8 1/2"

4' - 0" 1' - 6 1/2"

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MECH.

5' - 8 1/2"

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5' - 6"

2'-3" 3'-3" 2'-3" 6'-4"

5' - 6"

76' - 0"

18' - 0"

18' - 0"

\ /

18' - 0"

joists hung on concrete (this rear wall)


CONC. BUTTRESS FOR LATERAL SUPPORT, TYP, REFER TO ENG'D SPEC.

GARAGE


CENTRE DRAIN

6' - 4"

18' - 0"

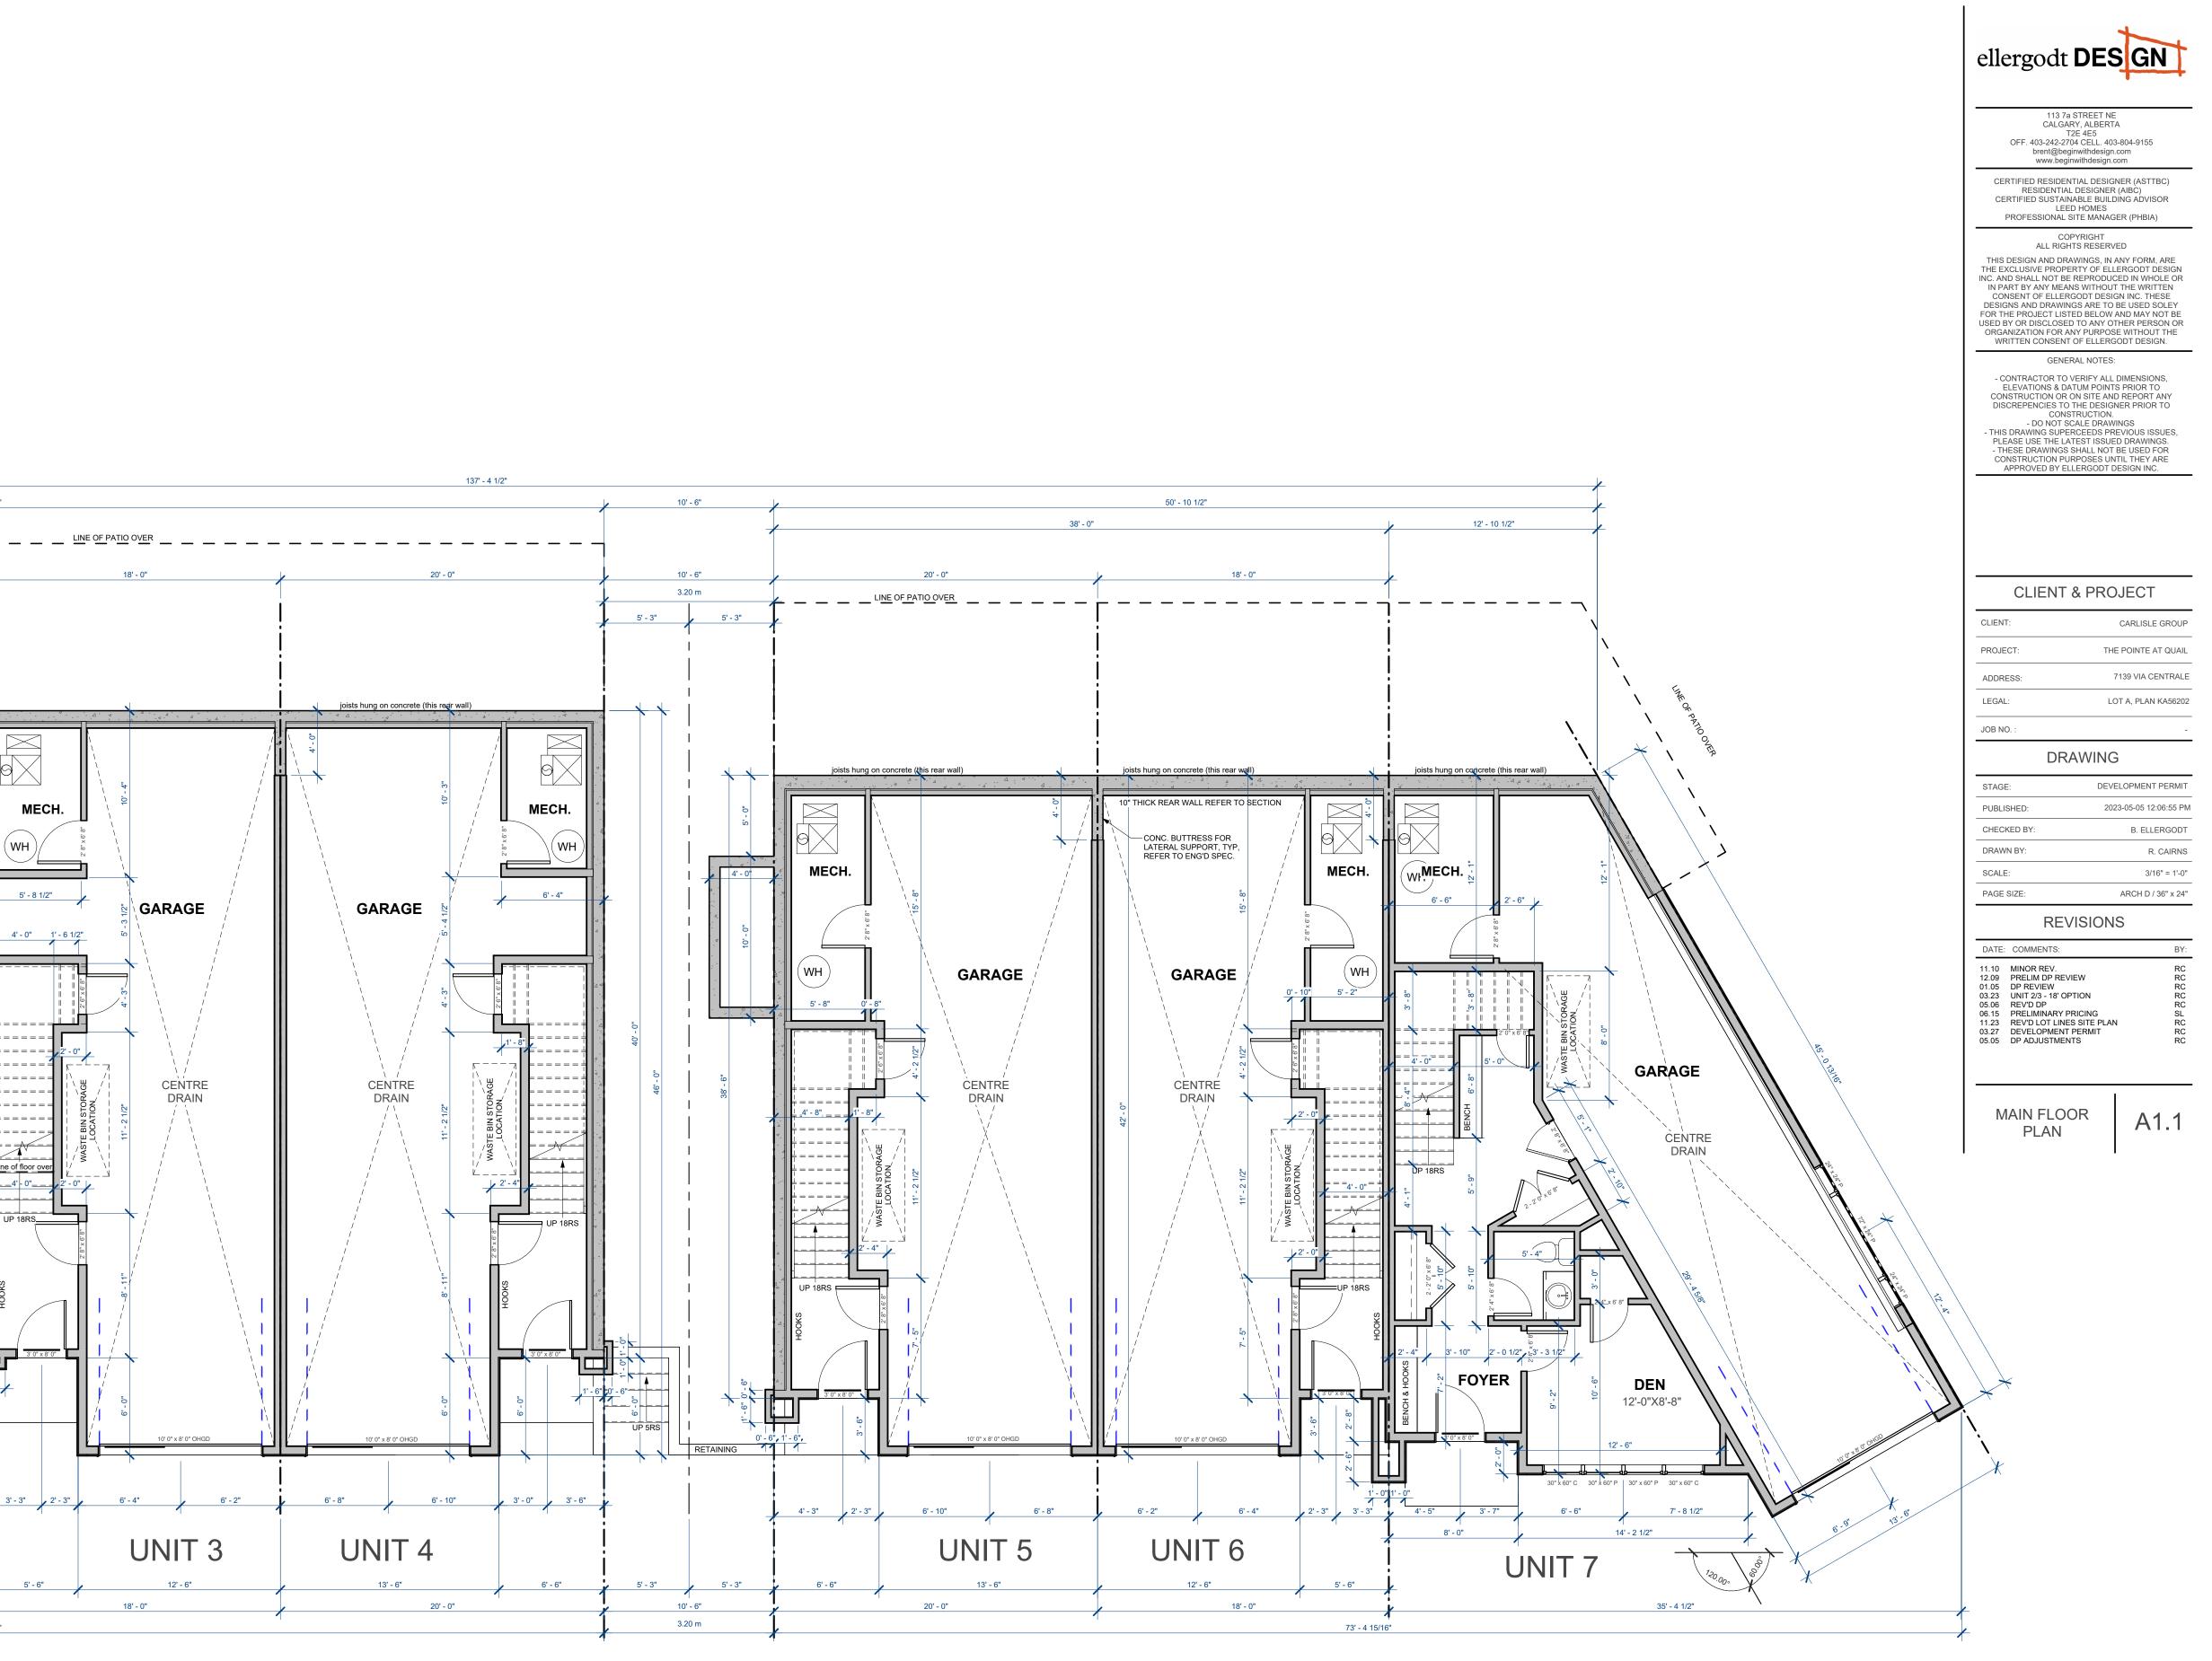


ALL MECHANICAL EQUIPMENT IS SUBJECT TO SITE INSTALLATION ADJUSTMENTS,

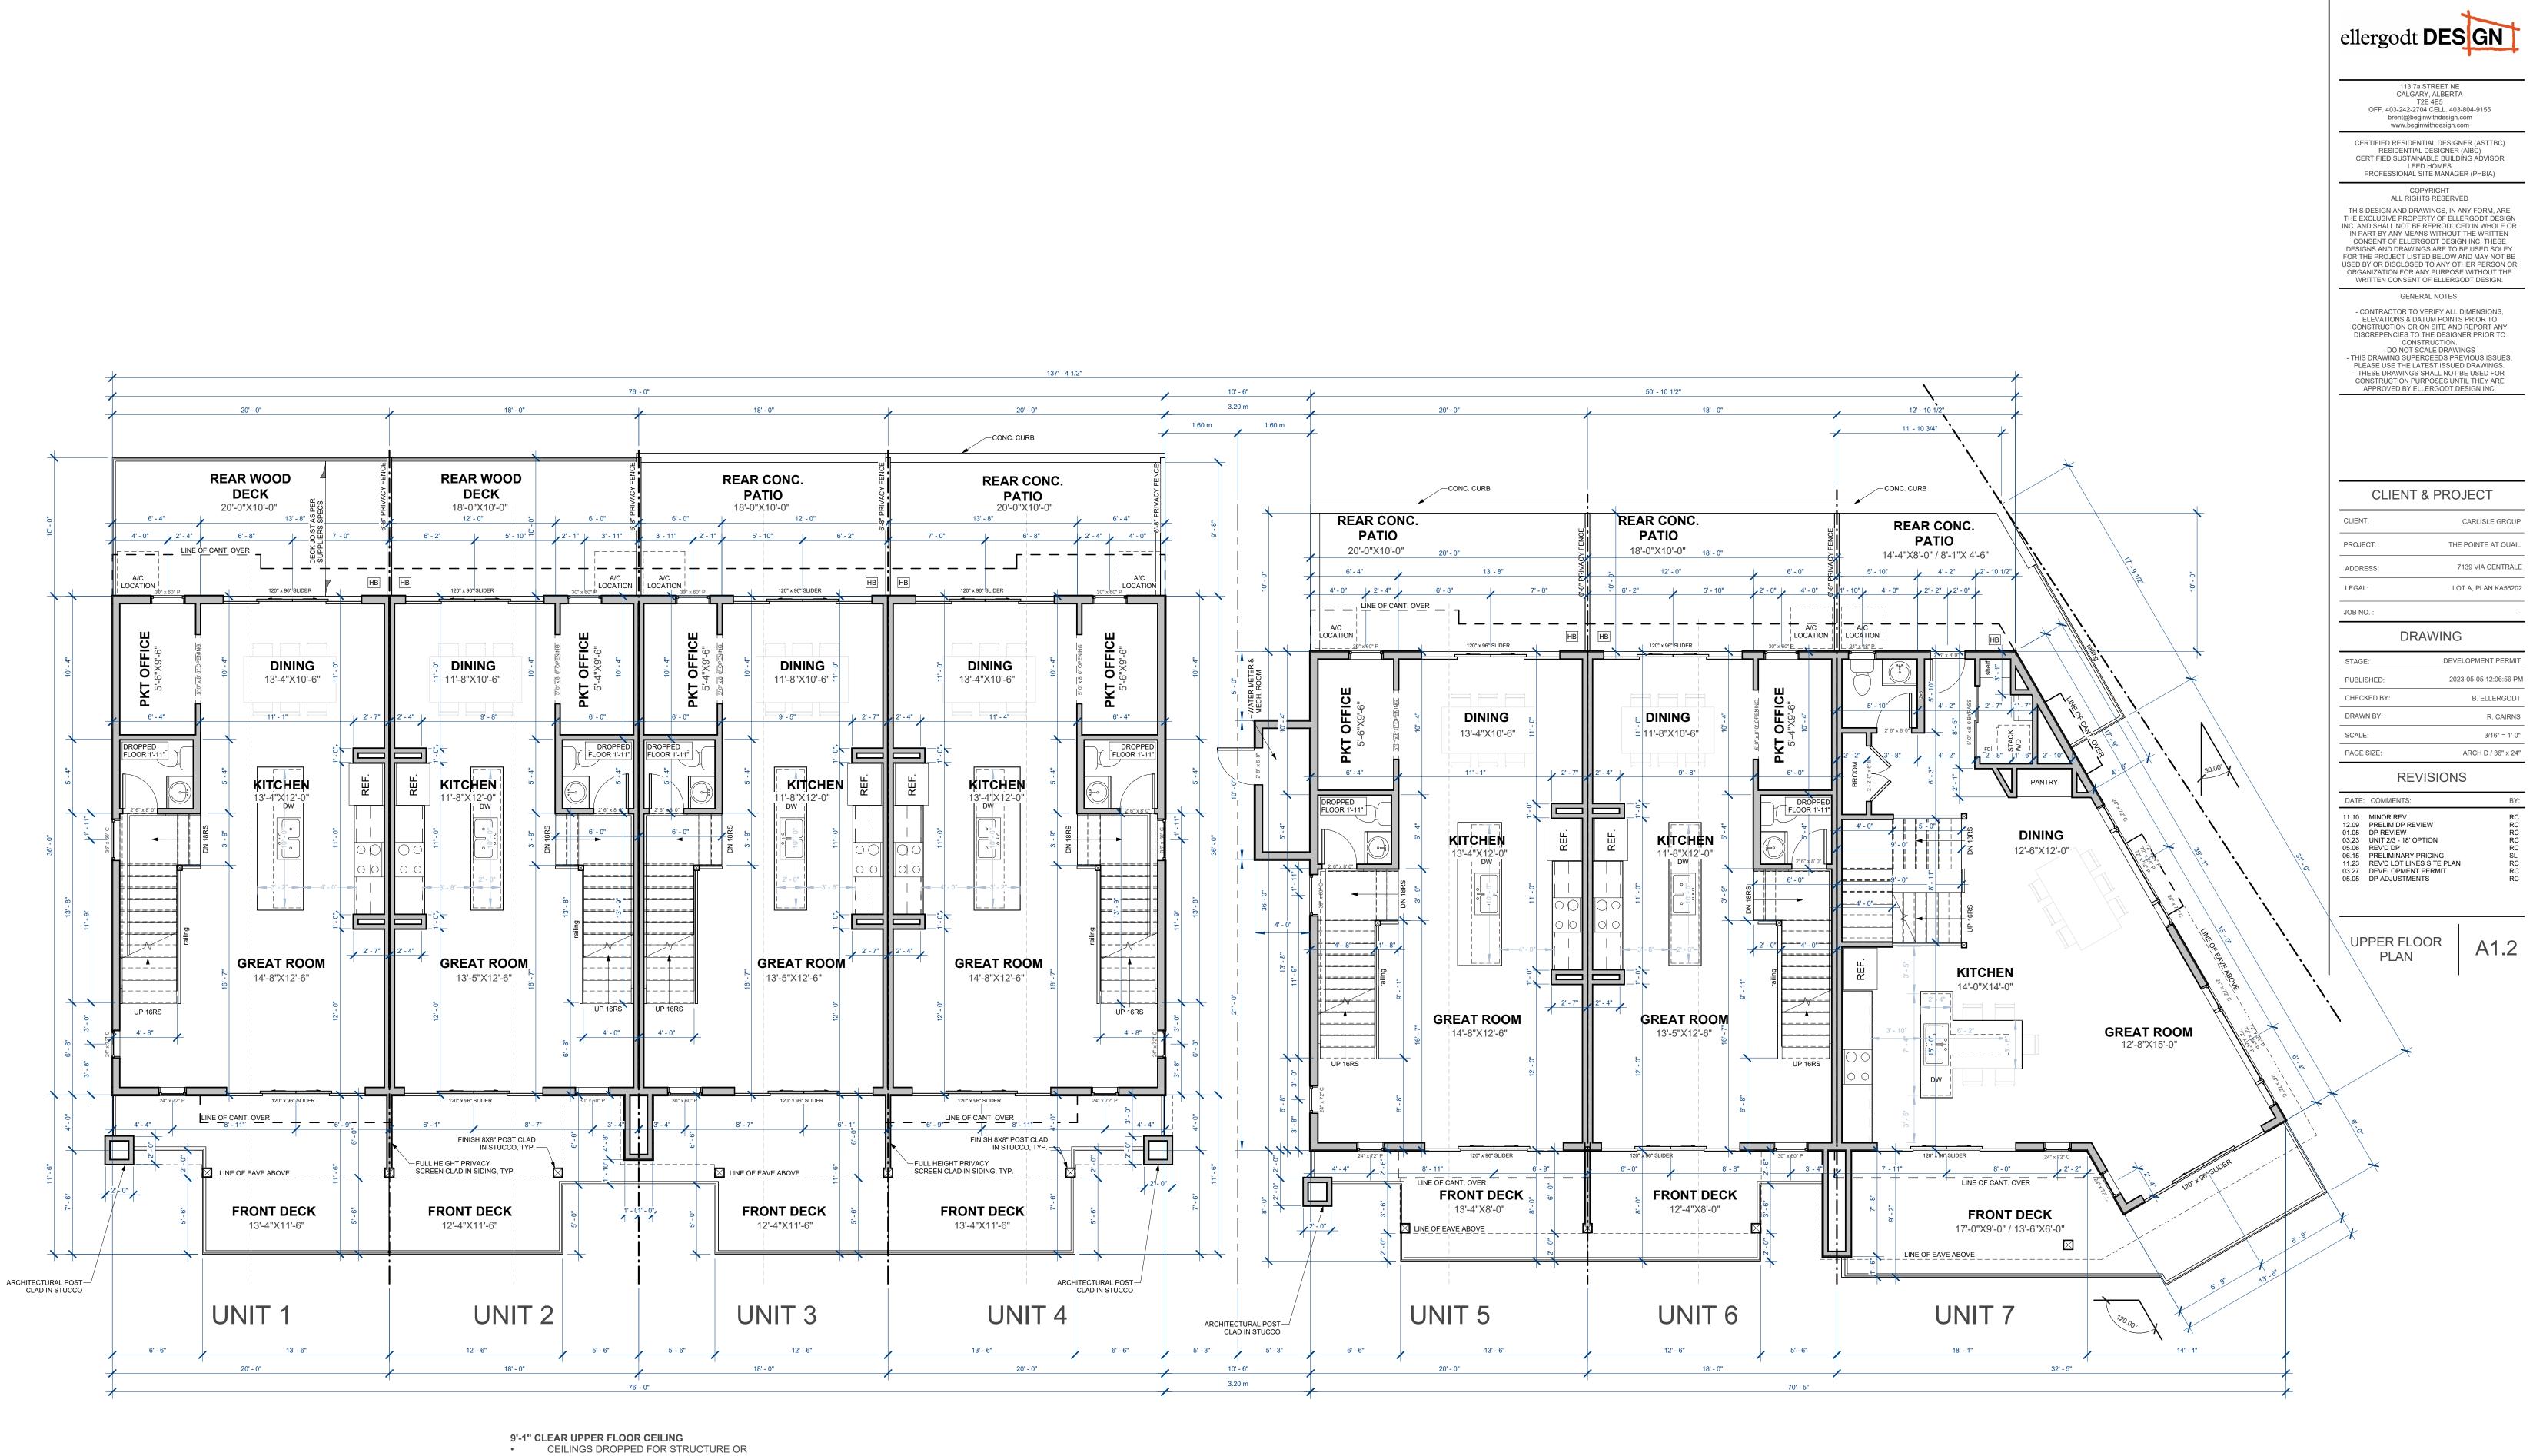

<sup>•</sup> 


-<u>PROPOSED UPPER FLOOR PLAN</u> <u>3/16" = 1'-0"</u>

MECH WHERE REQUIRED TOPS OF WINDOWS @ 8'-0" UNO ENG. HEADERS FOR OPENINGS WIDER THAN 5' •

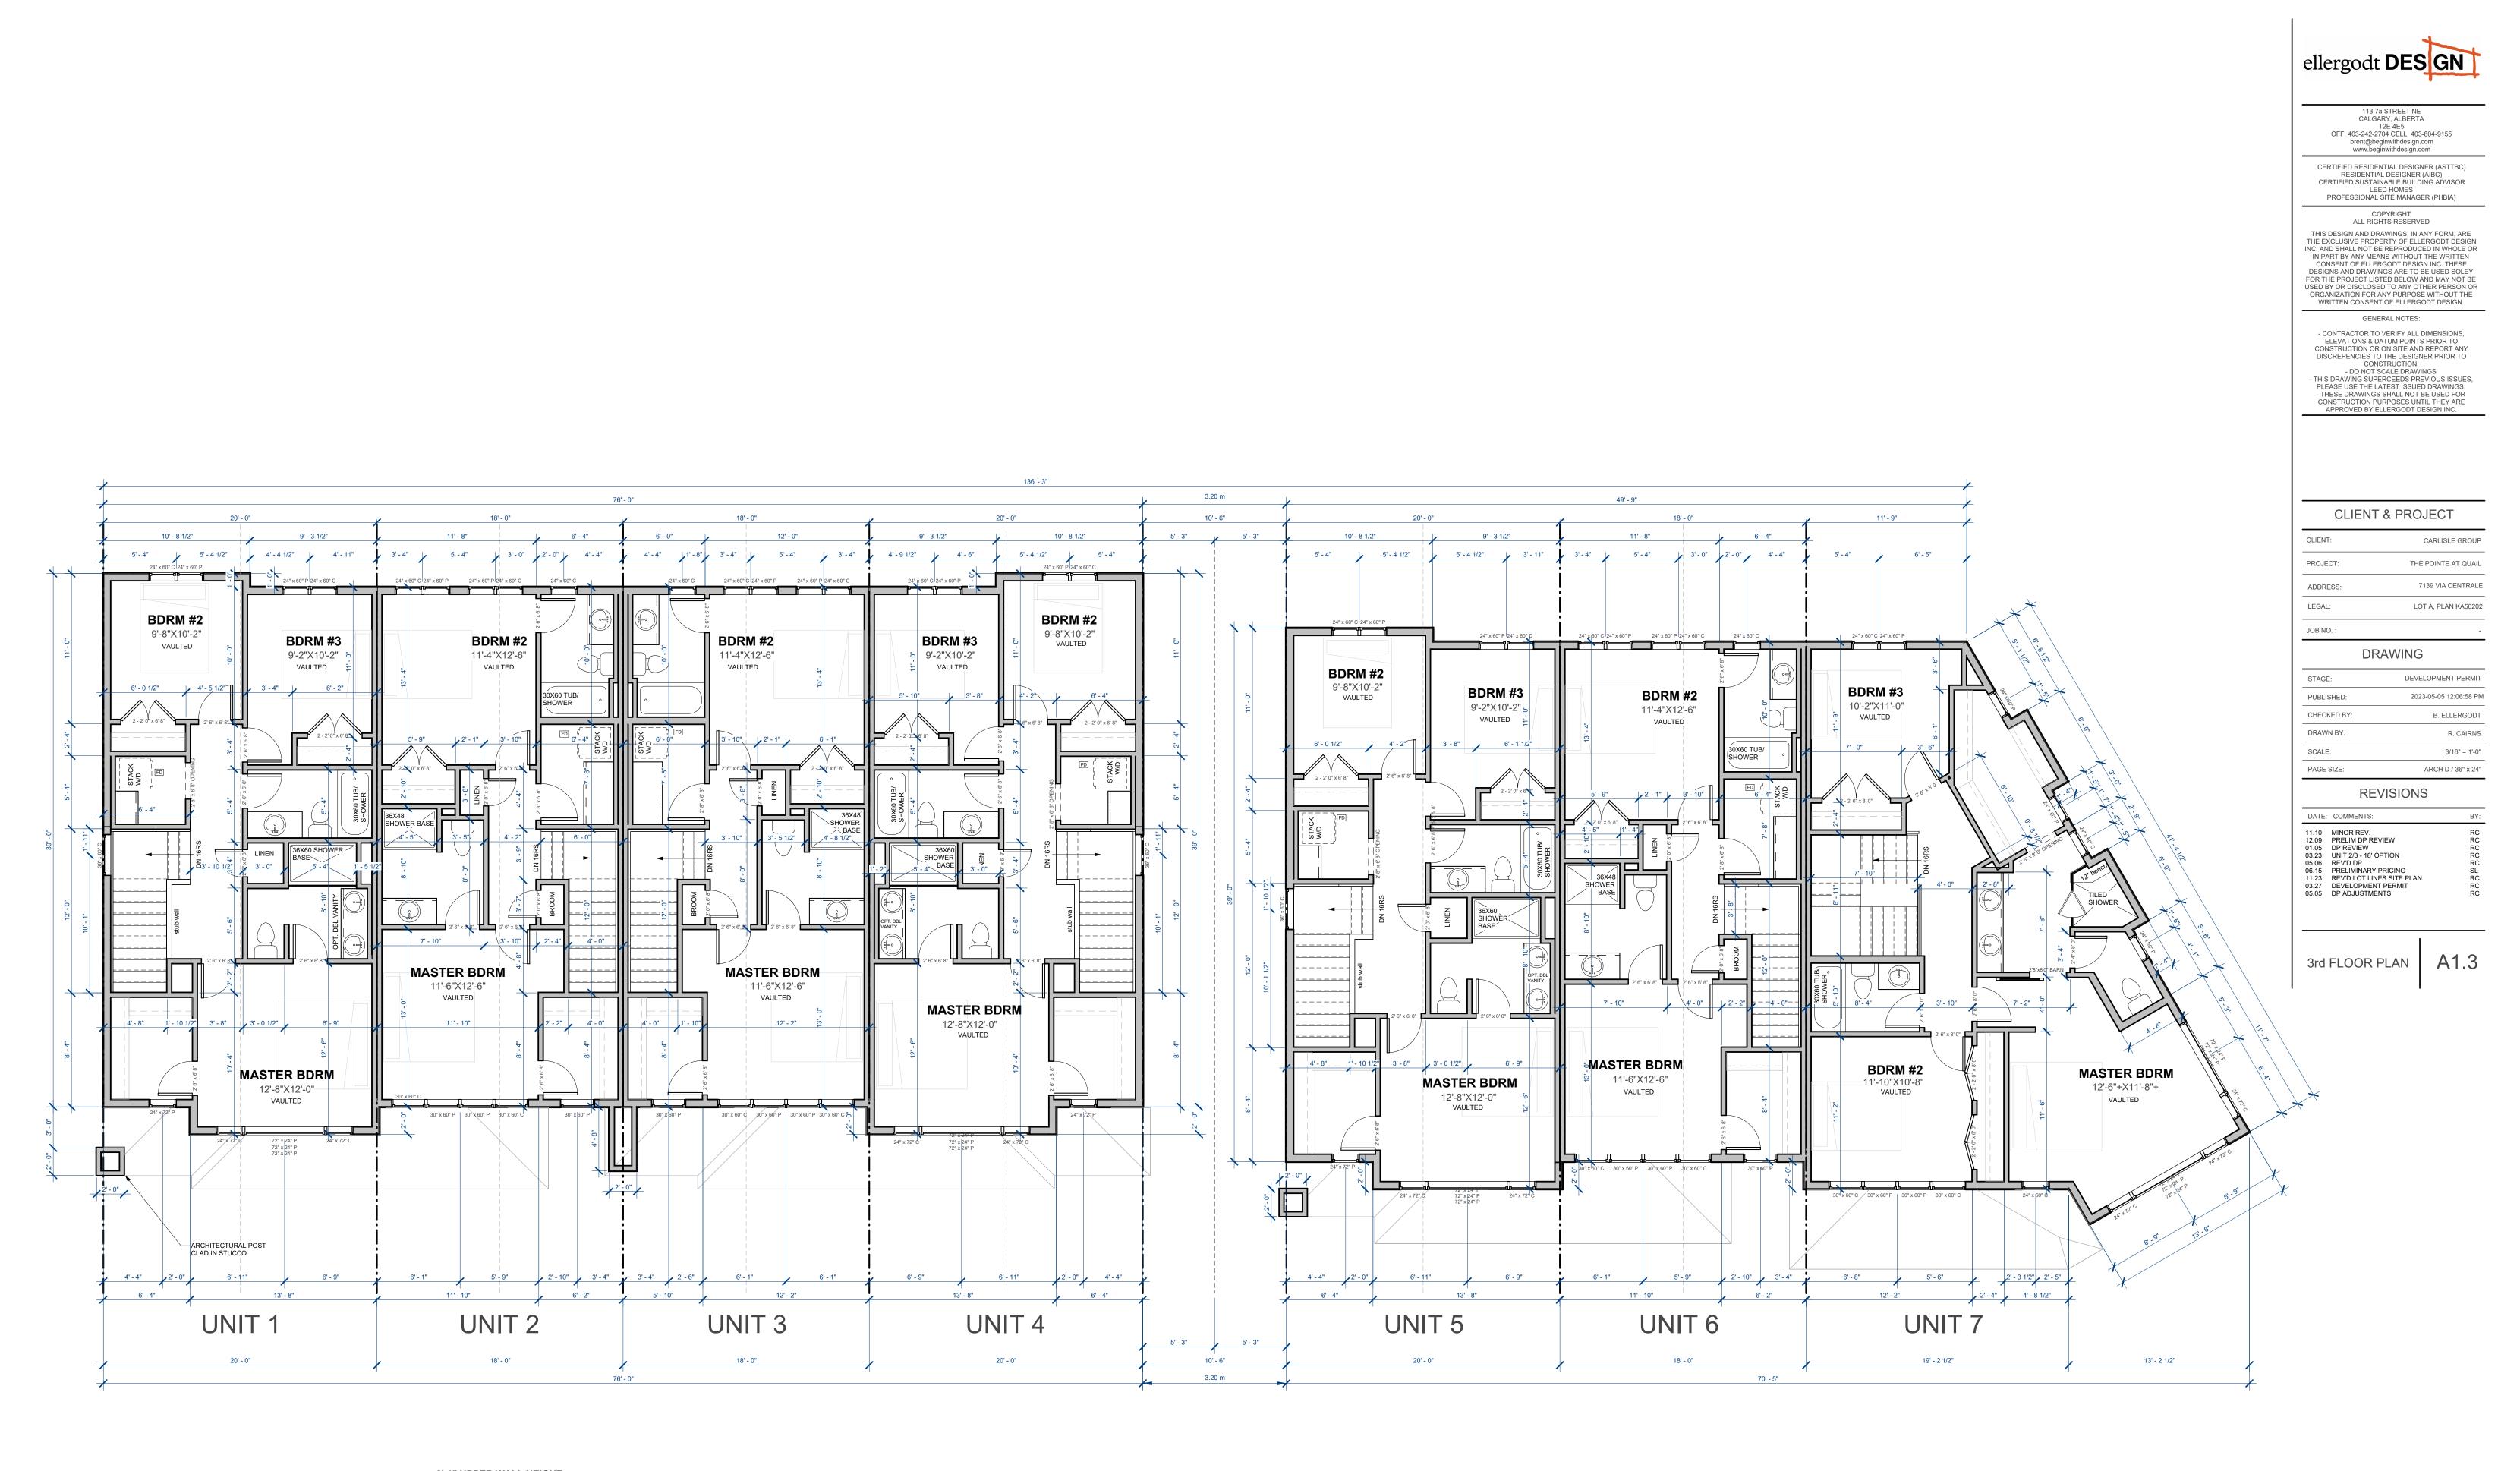


- PROPOSED THIRD FLOOR PLAN 3/16" = 1'-0" 8'-1" UPPER WALL HEIGHT
TOPS OF WINDOWS ON ELEVATIONS
ENG. HEADERS FOR OPENINGS WIDER THAN 5'


### -(1) PROPOSED ROOF PLAN 3/16" = 1'-0"

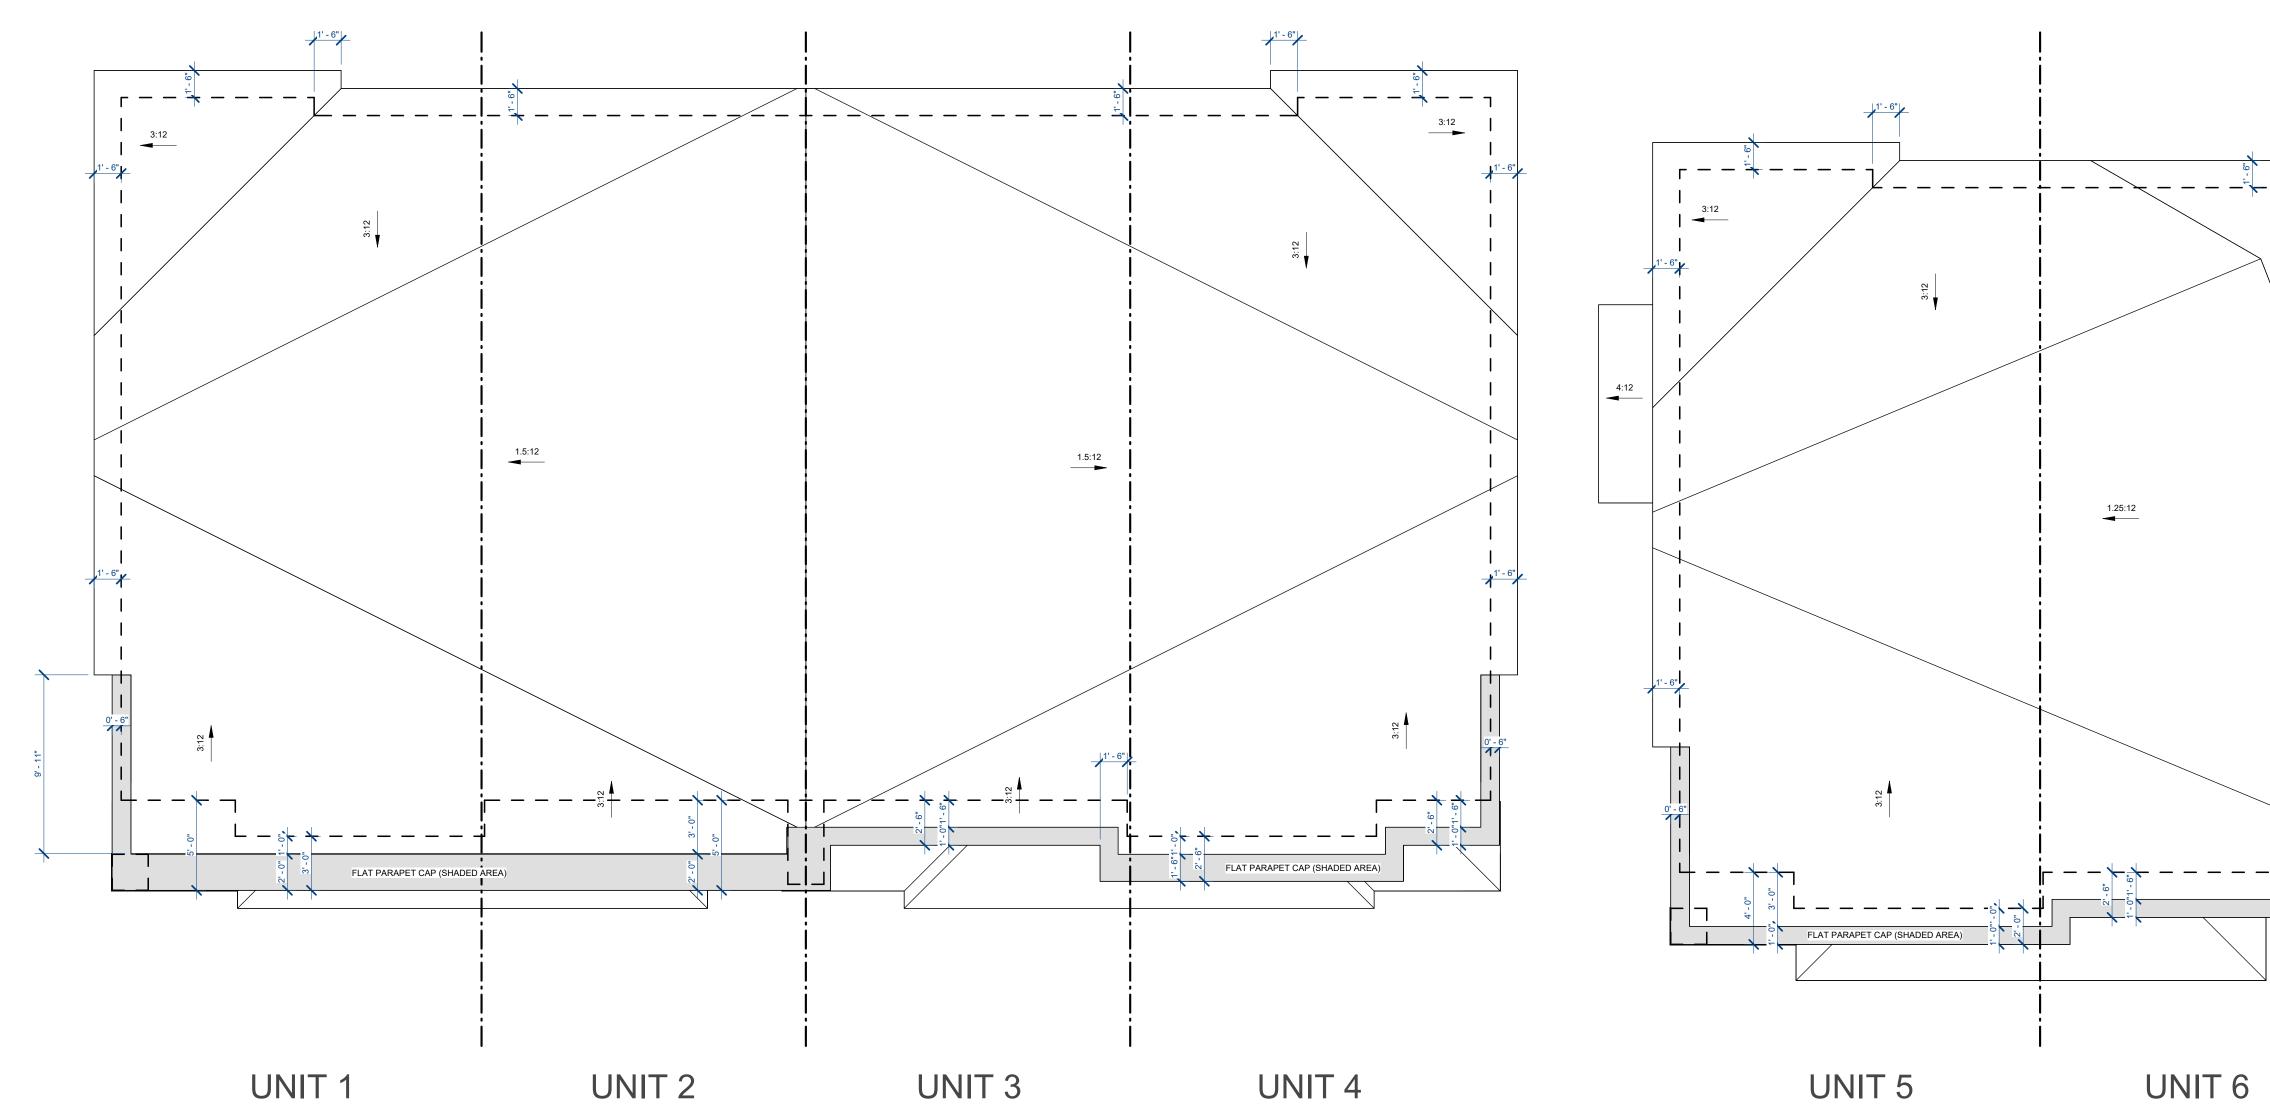

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1		C	LIENT & PROJECT
		CLIENT:	CARLISLE GROUP
		PROJECT: 	THE POINTE AT QUAIL
ĺ		LEGAL:	LOT A, PLAN KA56202
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	3:12	12.09 PRI 01.05 DP 03.23 UN 05.06 RE 06.15 PRI 11.23 RE 03.27 DE	DMMENTS:     BY       NOR REV.     RC       ELIM DP REVIEW     RC       REVIEW     RC       IT 2/3 - 18' OPTION     RC       U'D DP     RC       ELIMINARY PRICING     SL       V'D LOT LINES SITE PLAN     RC       VELOPMENT PERMIT     RC       ADJUSTMENTS     RC
		RO	OF PLAN A1.4
		RO	
FLAT PARAPET CA	P (SHADED AREA)	•	




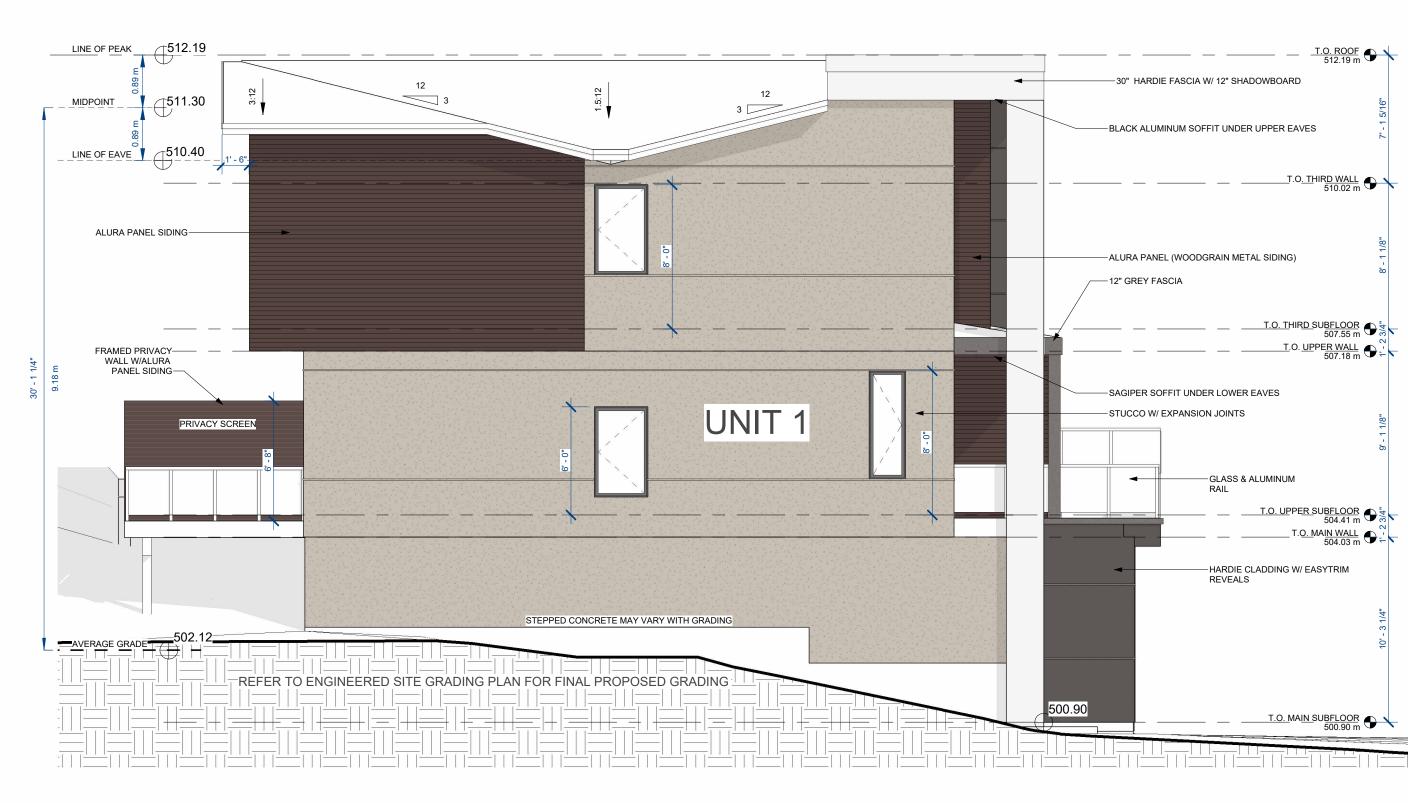

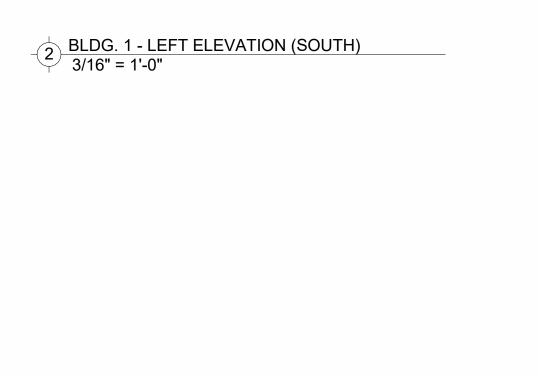

### EXTERIOR CLADDING LEGEND




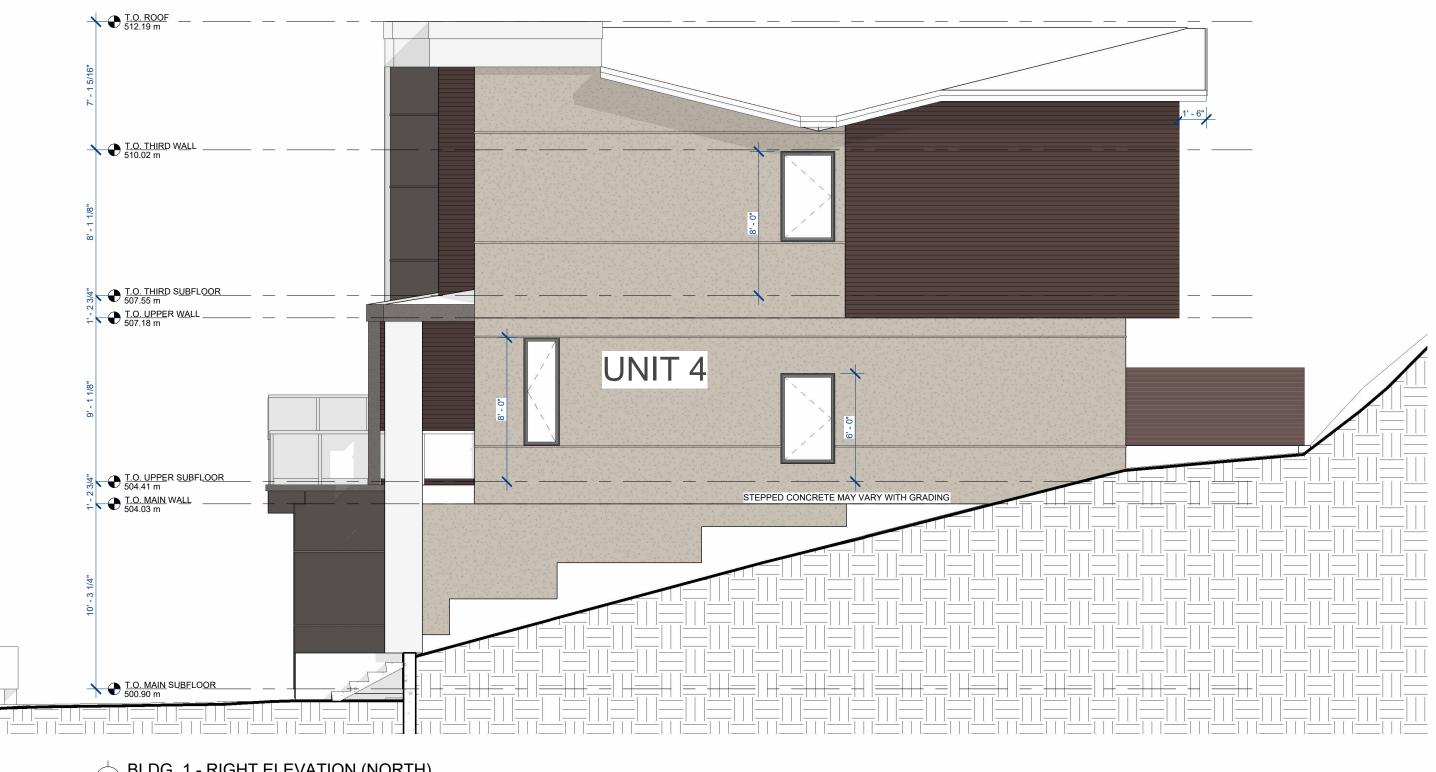


-4 BLDG. 1 - RIGHT ELEVATION (NORTH) 3/16" = 1'-0"


# BLDG. 1 - REAR ELEVATION (WEST) 3/16" = 1'-0"




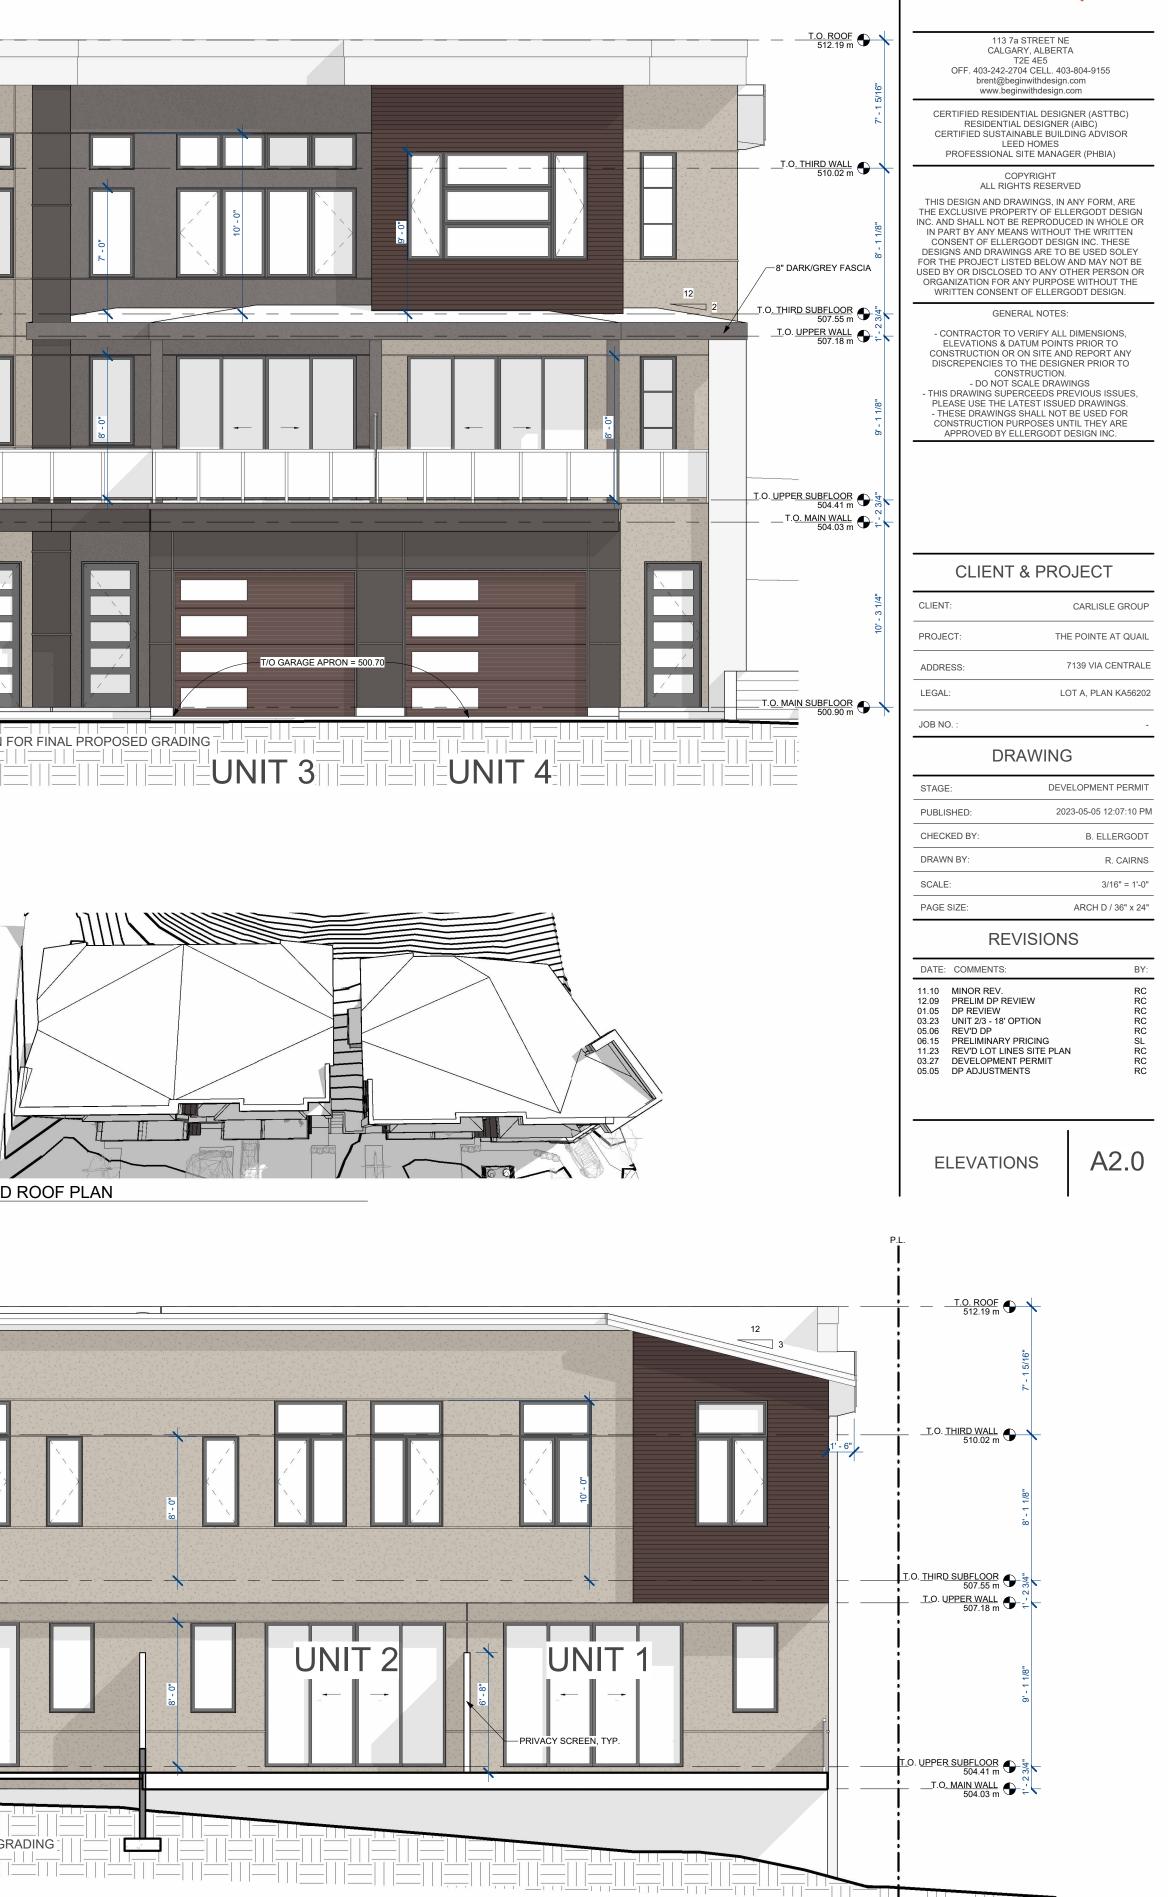




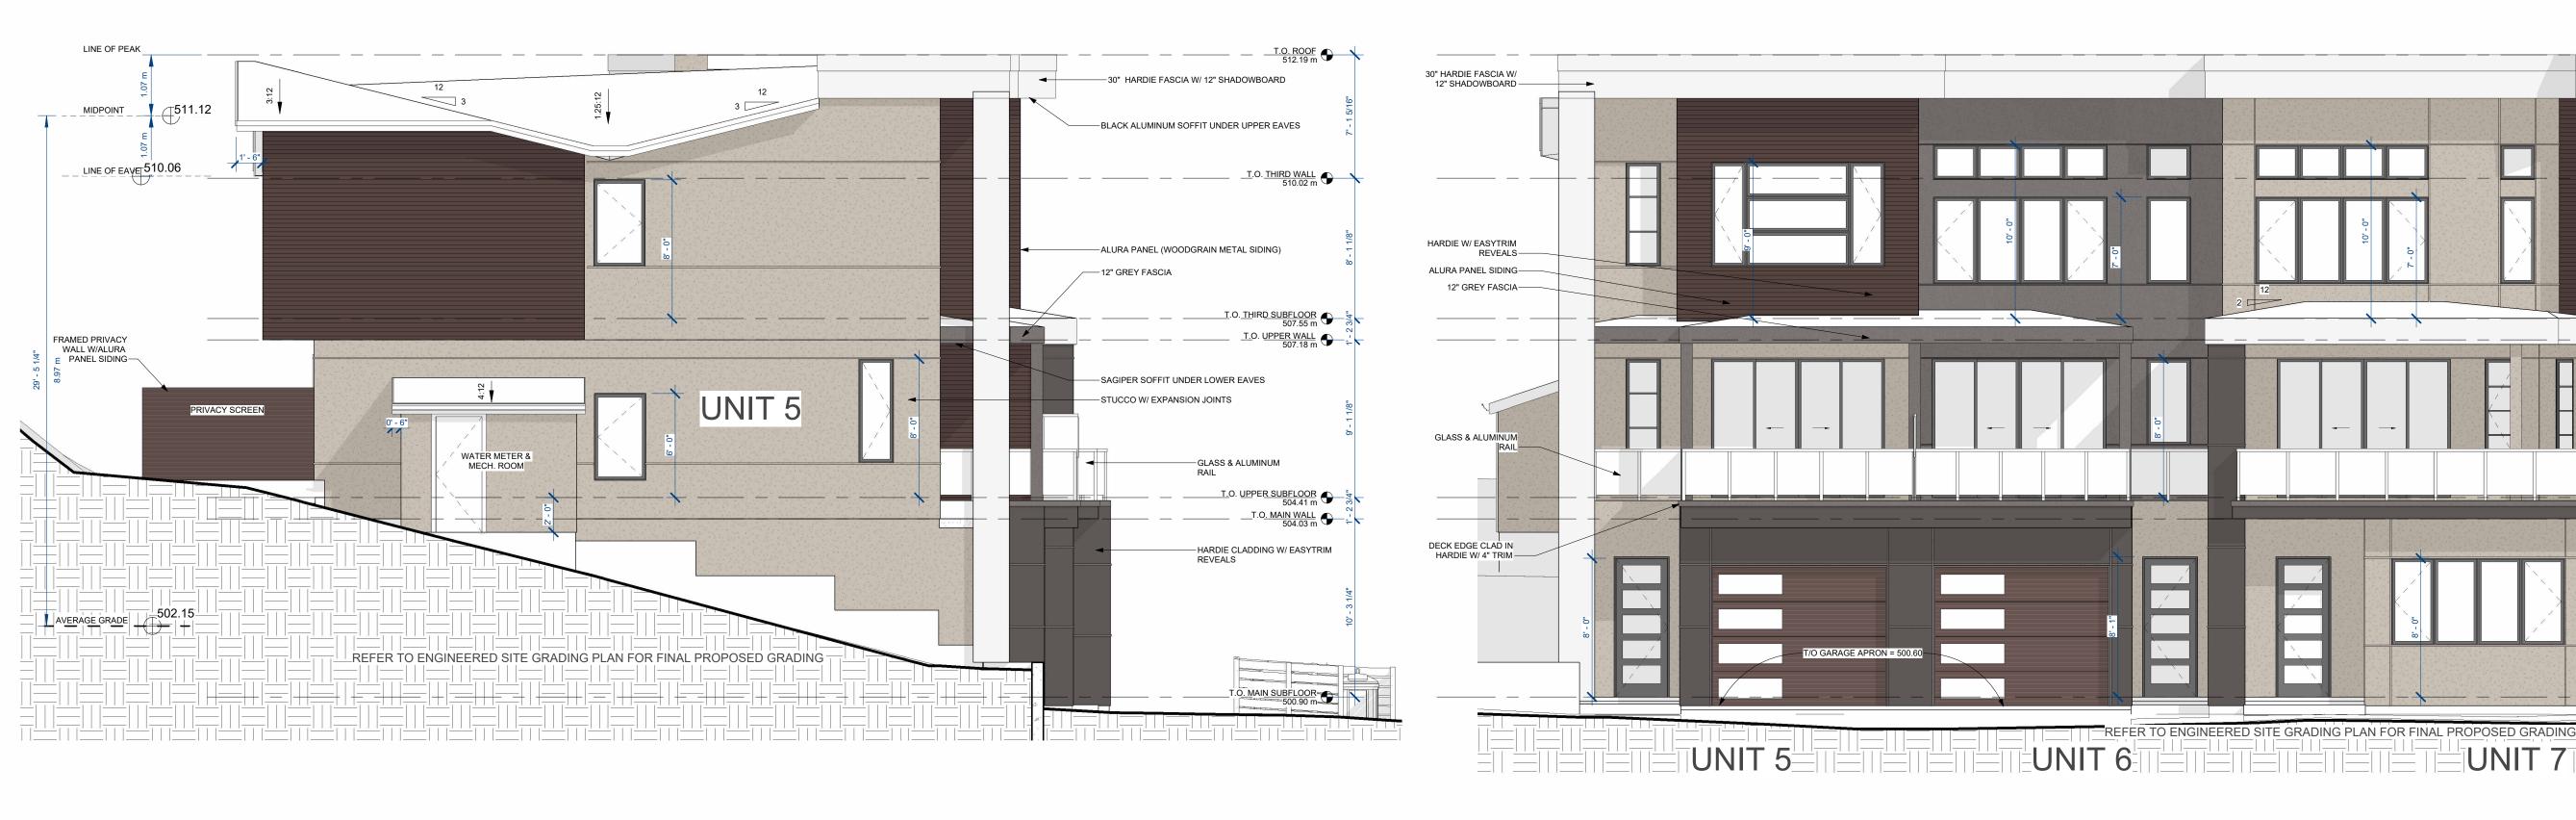

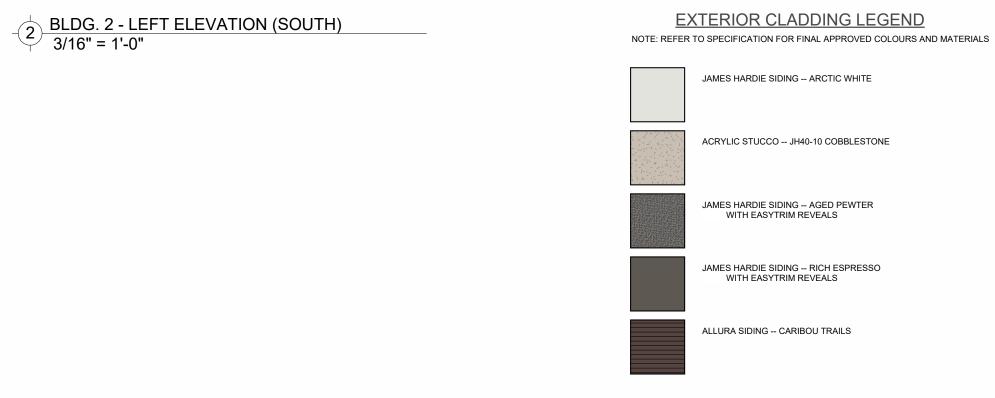


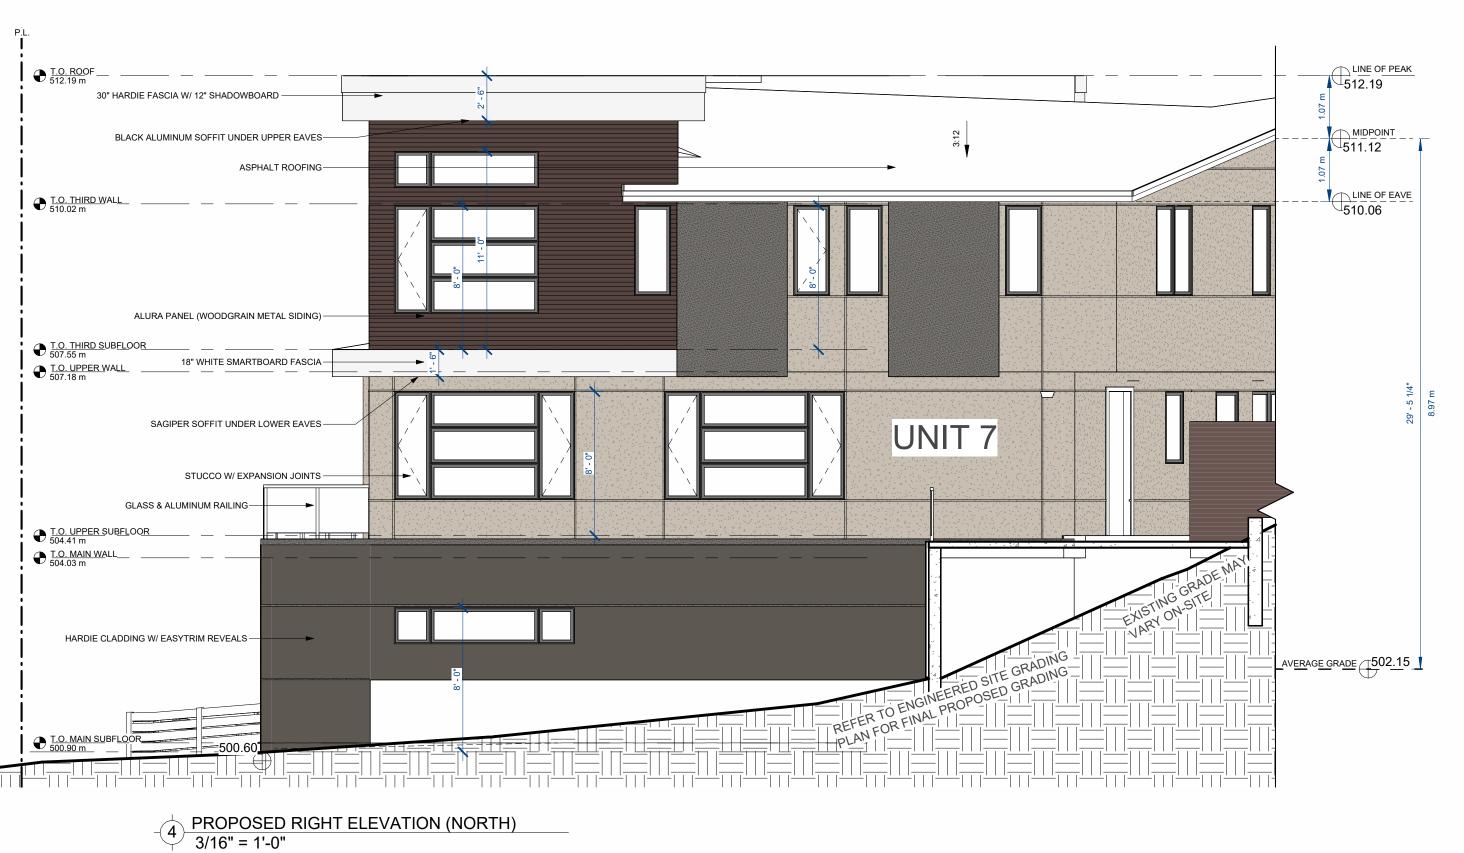




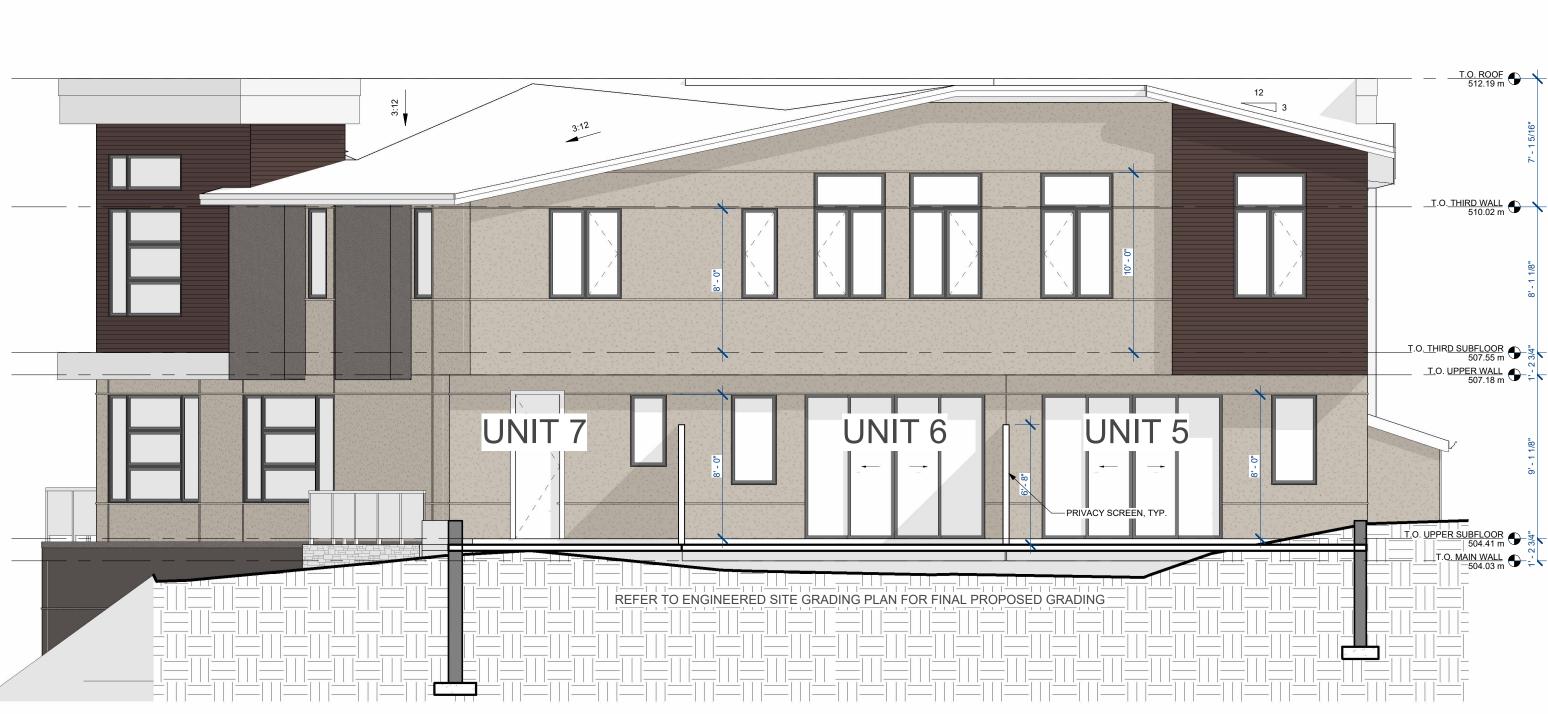



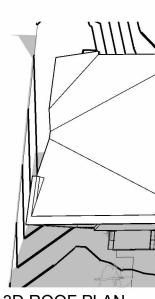

### BLDG. 2 - FRONT ELEVATION (EAST)

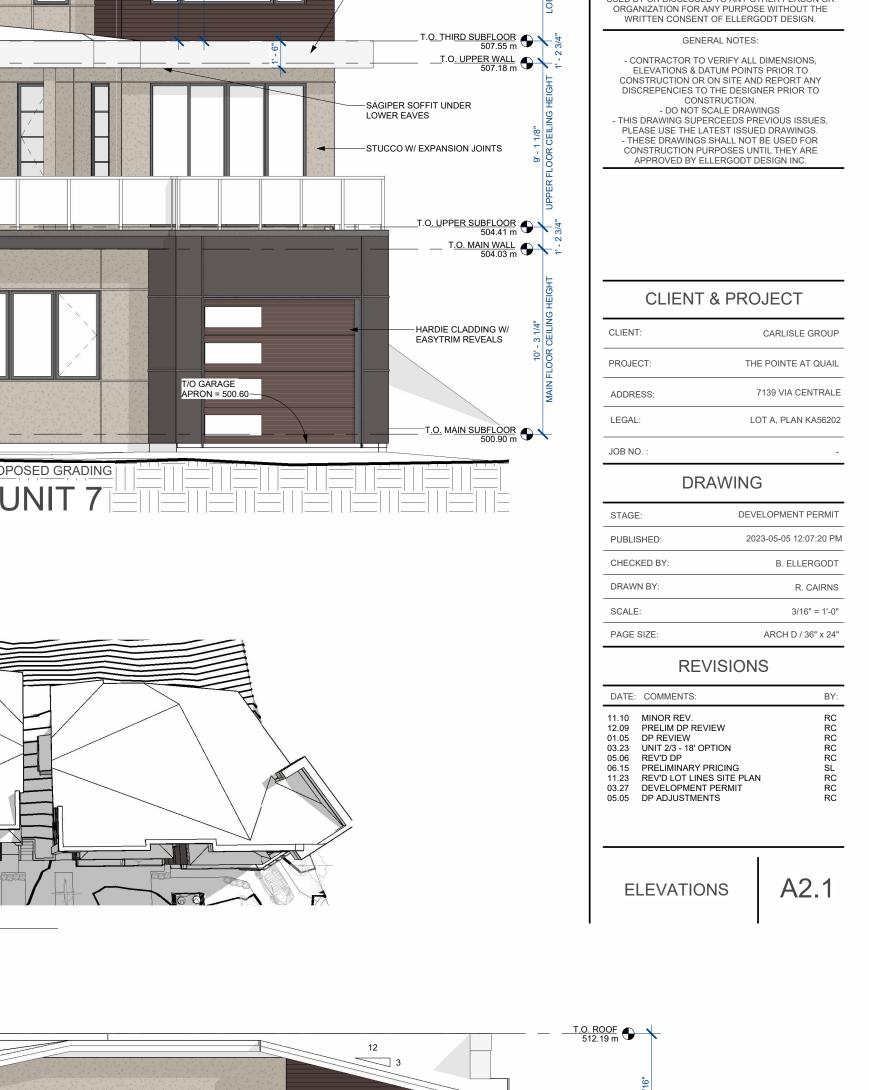

SHADOWBOARD

-----BLACK ALUMINUM SOFFIT UNDER UPPER EAVES

—ALURA PANEL (WOODGRAIN

-18" WHITE SMARTBOARD FASCIA

METAL SIDING)

- \_\_\_\_\_\_ T.<u>O. THIRD WALL</u> 510.02 m

+ +

F

E



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T2E 4E5 OFF. 403-242-2704 CELL. 403-804-9155

brent@beginwithdesign.com www.beginwithdesign.com

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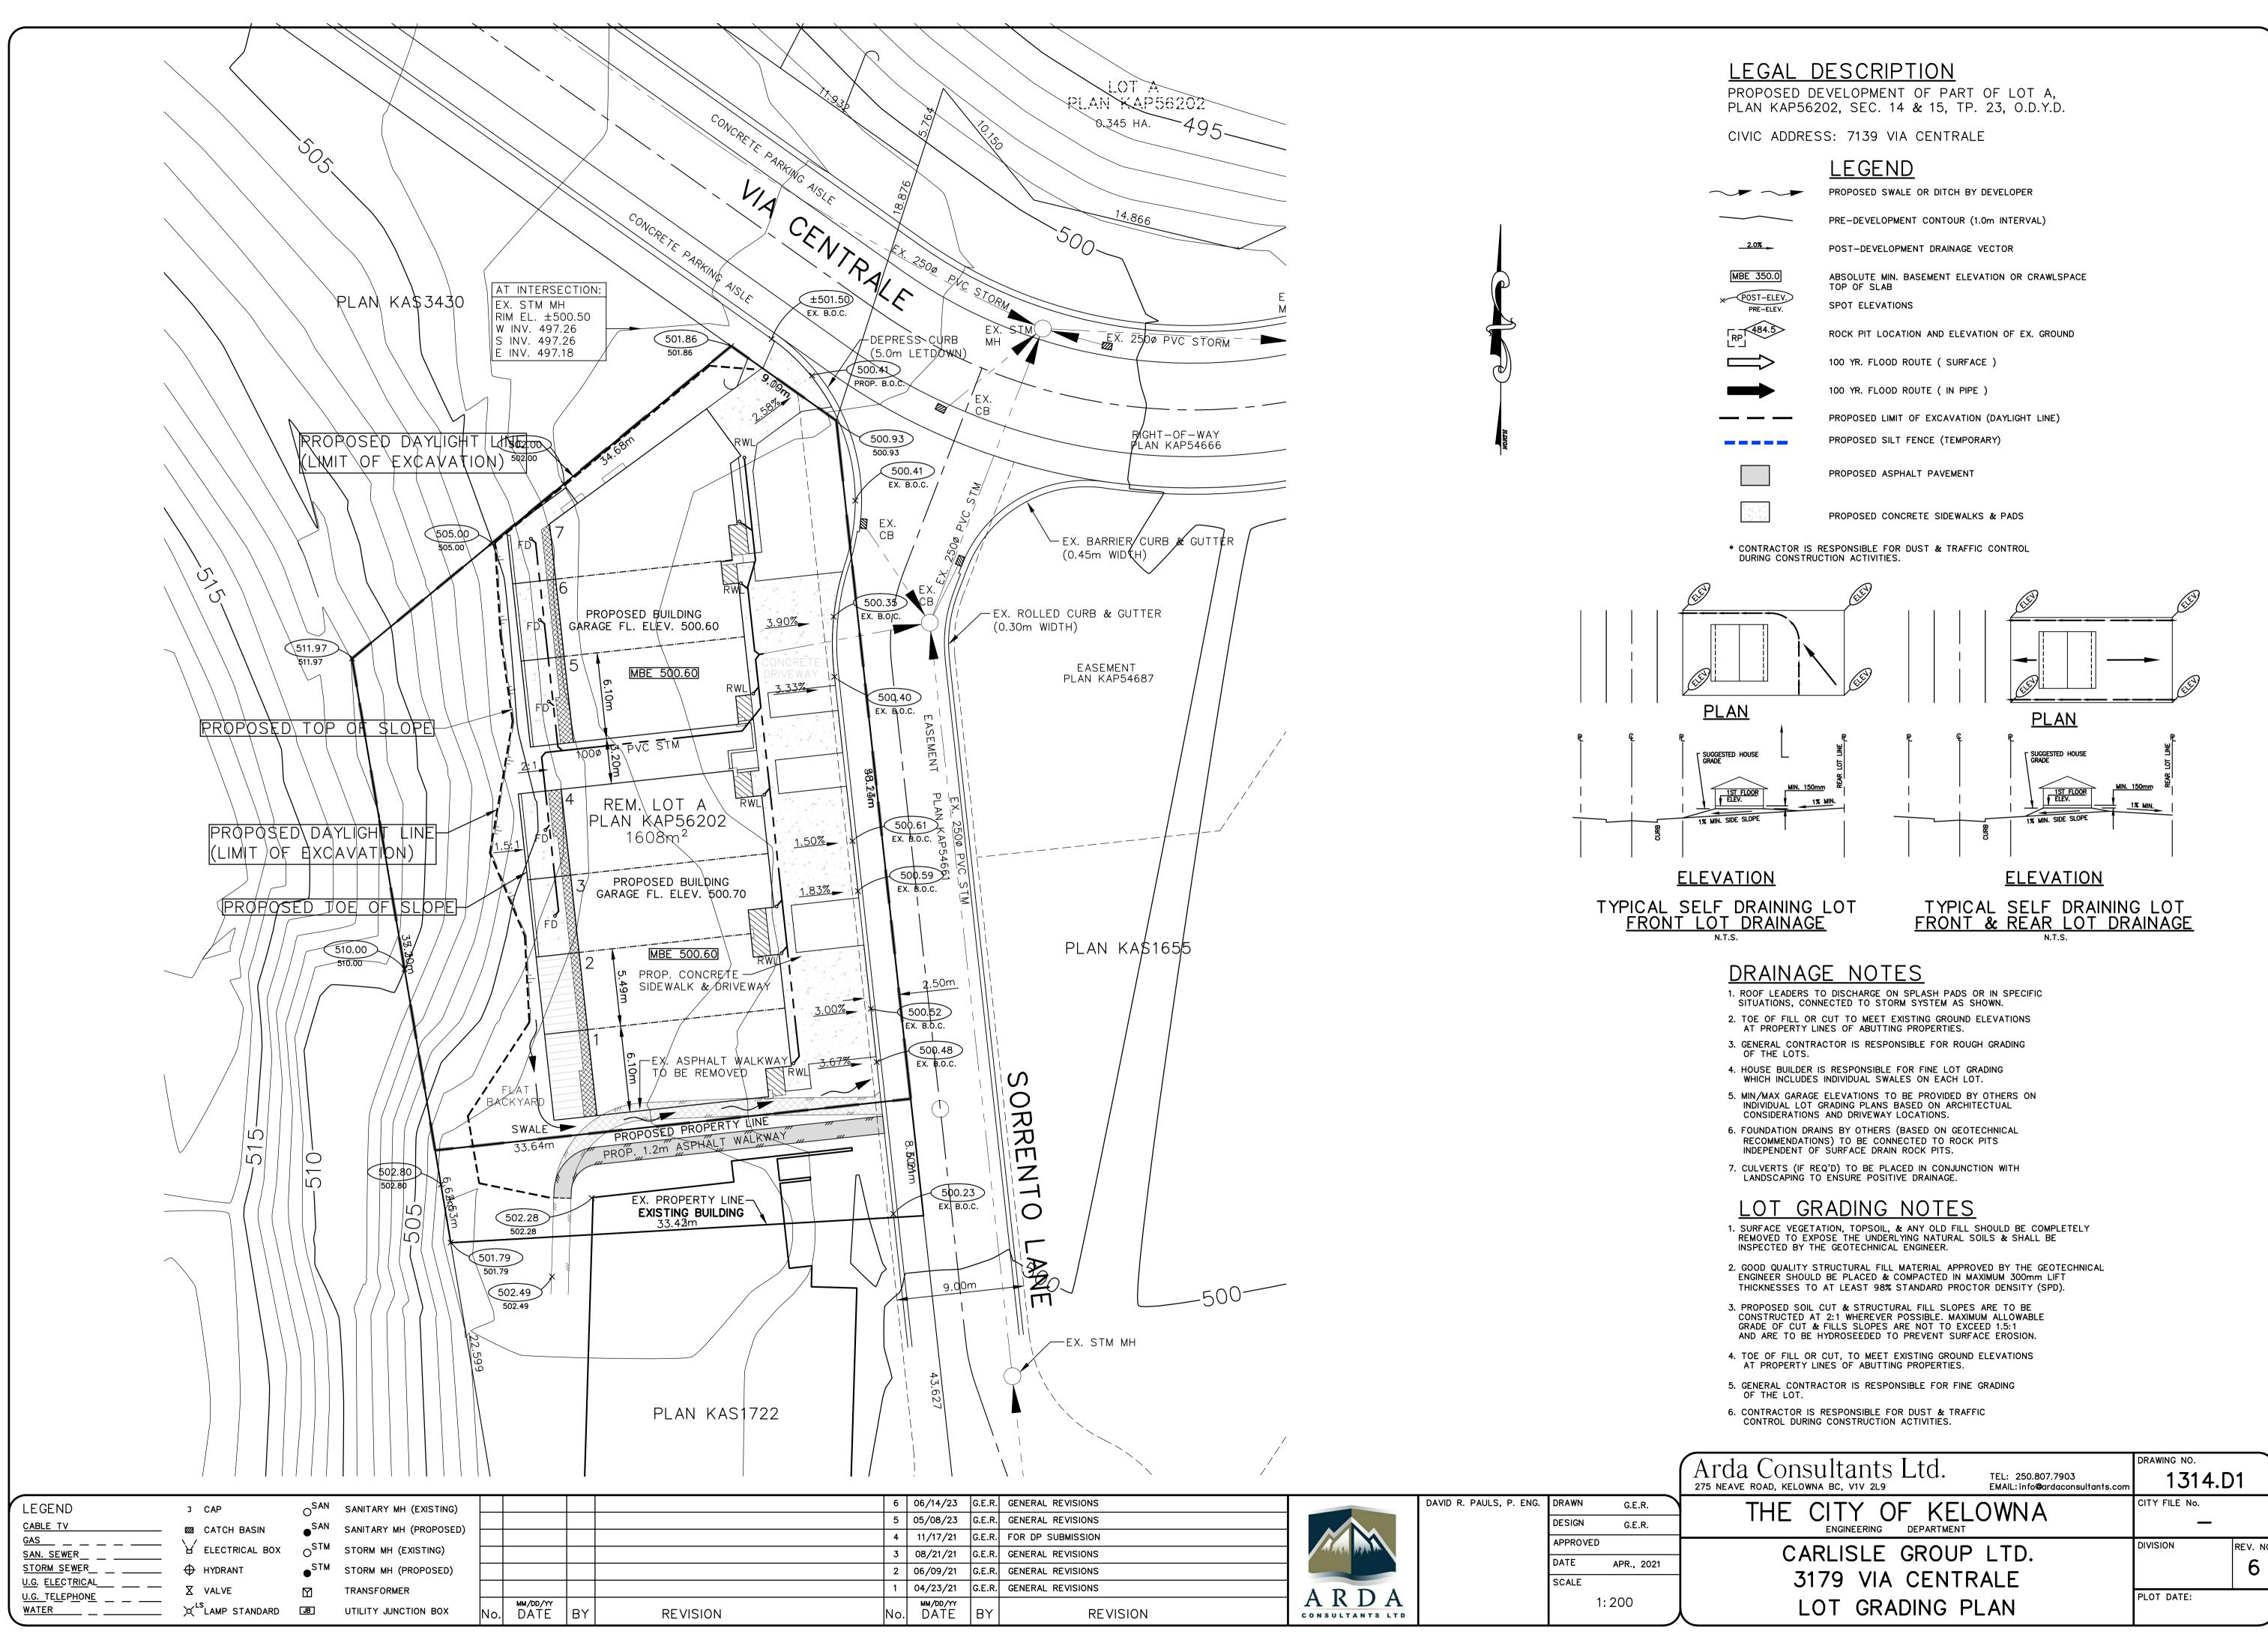
LEED HOMES PROFESSIONAL SITE MANAGER (PHBIA)

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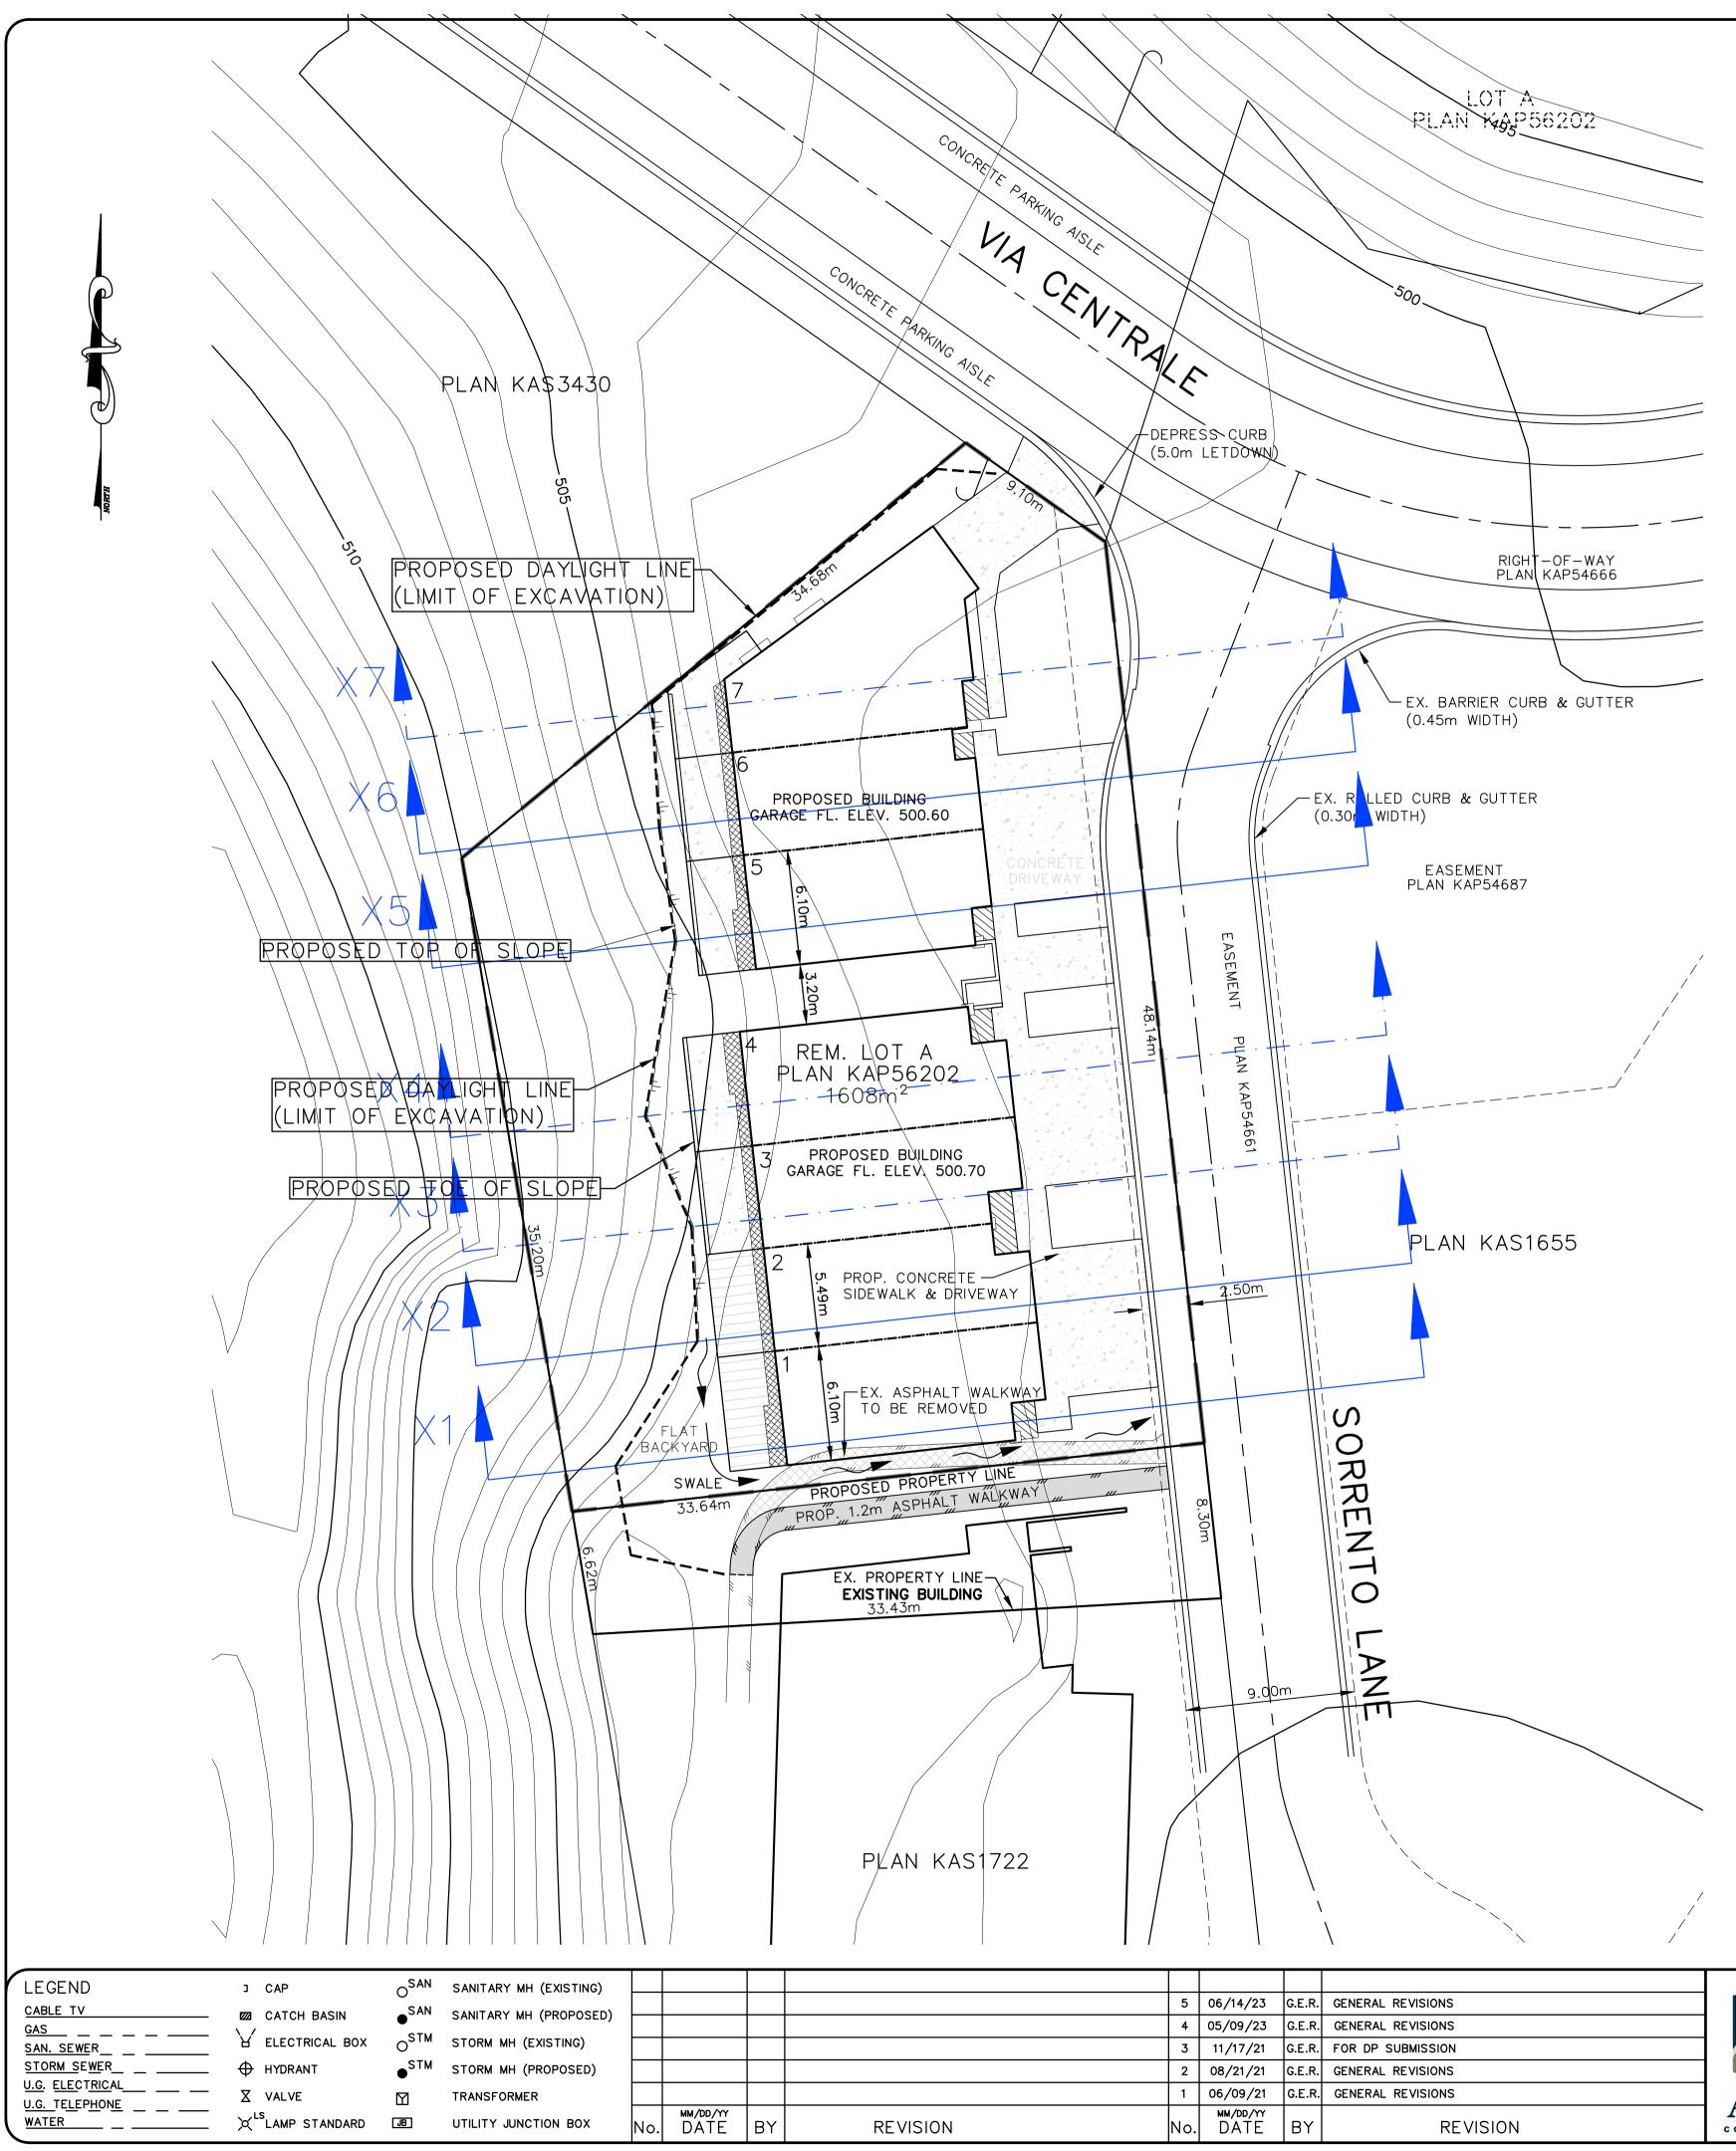
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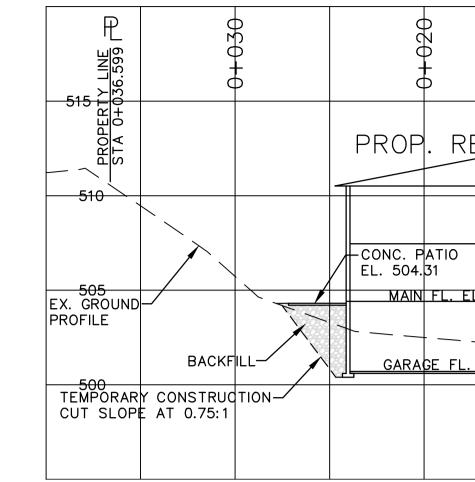
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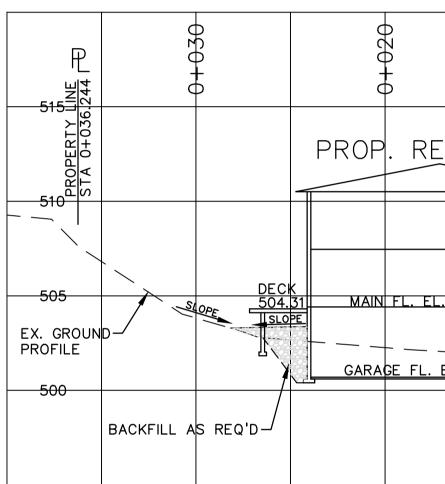
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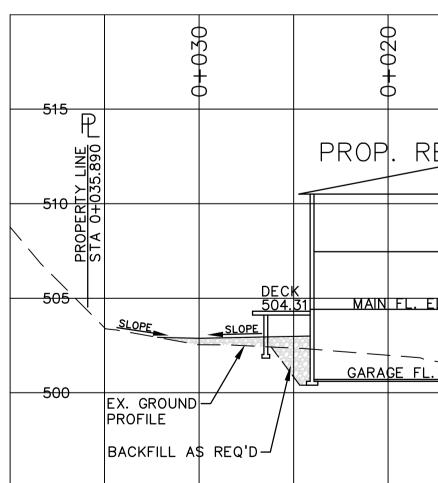


	PROPOSED SWALE OR DITCH BY DEVELOPER
	PRE-DEVELOPMENT CONTOUR (1.0m INTERVAL)
2.0%	POST-DEVELOPMENT DRAINAGE VECTOR
350.0	ABSOLUTE MIN. BASEMENT ELEVATION OR CRAWLSPACE TOP OF SLAB
DST-ELEV.	SPOT ELEVATIONS
484.5	ROCK PIT LOCATION AND ELEVATION OF EX. GROUND
$\Rightarrow$	100 YR. FLOOD ROUTE ( SURFACE )
	100 YR. FLOOD ROUTE ( IN PIPE )
	PROPOSED LIMIT OF EXCAVATION (DAYLIGHT LINE)
	PROPOSED SILT FENCE (TEMPORARY)
	PROPOSED ASPHALT PAVEMENT









		N						Arda Consultants Ltd. TEL: 250.807.7903 275 NEAVE ROAD, KELOWNA BC, VIV 2L9 EMAIL: info@ardaconsultants.cor	DRAWING NO. 1314	.X1
					DAVID R. PAULS, P. ENG.	DRAWN G.E.	R.	THE CITY OF KELOWNA	CITY FILE No.	
		+				DESIGN G.E.	R.		-	
4	05/09/23	G.E.R.	GENERAL REVISIONS			APPROVED			DIVISION	REV. NO.
3	11/17/21	G.E.R.	FOR DP SUBMISSION	MARY WAR IN		DATE APR.,	2021	CARLISLE GROUP LTD.		<b>F</b>
2	08/21/21	G.E.R.	GENERAL REVISIONS			· · · · · · · · · · · ·	2021	3179 VIA CENTRALE		C
1	06/09/21	G.E.R.	GENERAL REVISIONS			scale H=1:200	)	JITS VIA CLIVINALL	PLOT DATE:	
No.	MM/DD/YY DATE	BY	REVISION	A K D A CONSULTANTS LTD		V=1:200		CROSS SECTIONS	FLOT DATE.	

# CROSS SECTION X1


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		9.0	0m	510
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# CROSS SECTION X2


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# CROSS SECTION X3

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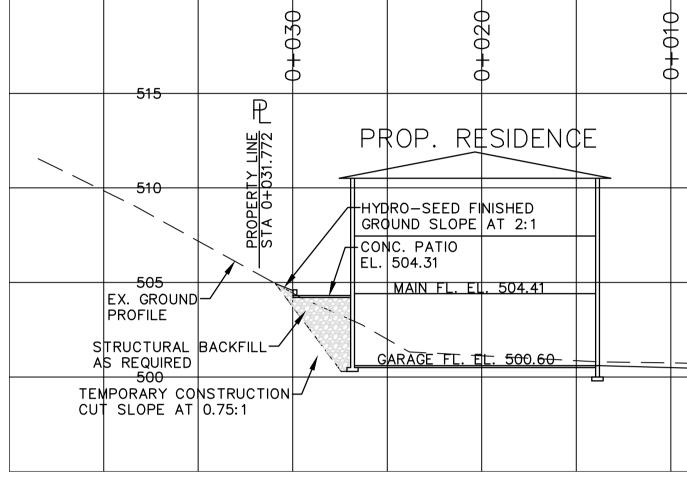


## CROSS SECTION X5

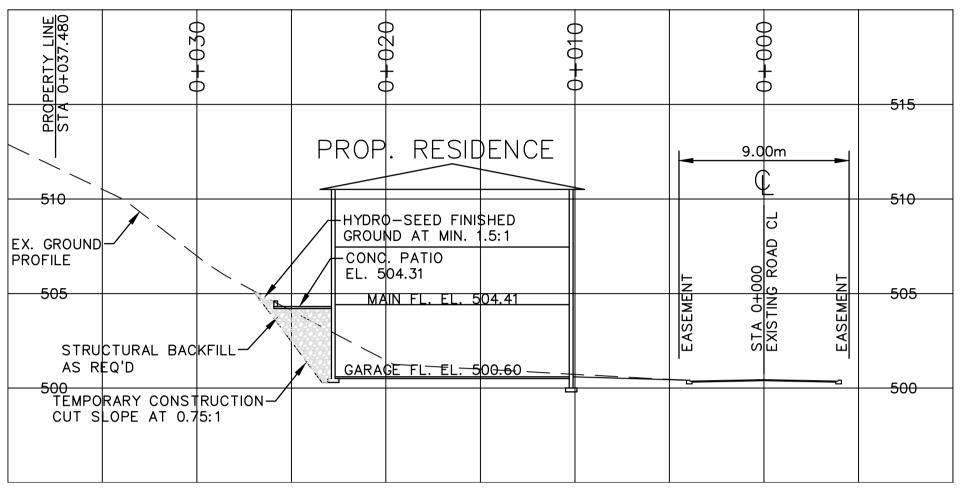


## CROSS SECTION X4
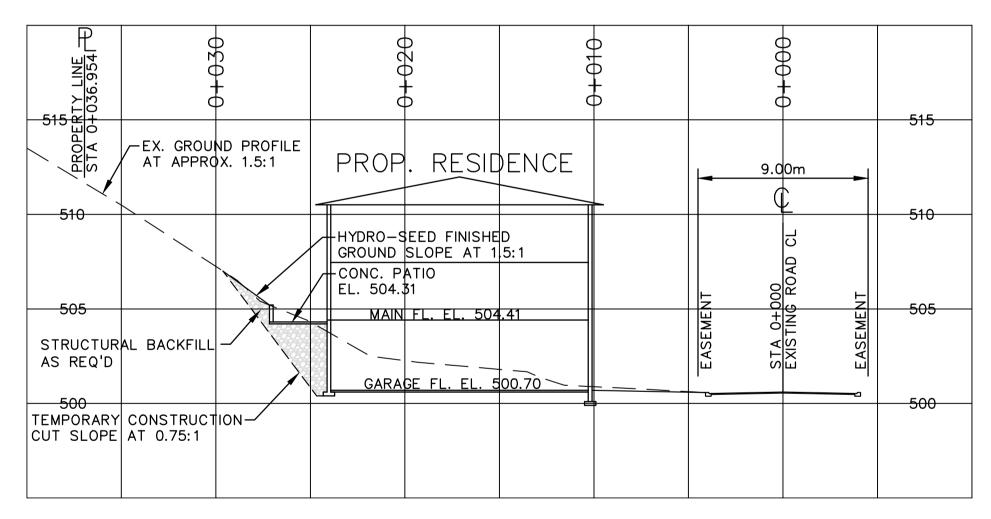
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LEGEND J CAP O <sup>SAN</sup> SANITARY MH (EXISTING)				DAVID R. PAULS, P. ENG. D	RAWN G.E.R. DESIGN G.E.R.	THE CITY OF KELOWNA	CITY FILE No.
GAS	3         05/09/23         G.E.R.			E	APPROVED	CARLISLE GROUP LTD.	DIVISION REV. NO.
STORM SEWER	1 08/21/21 G.E.R.	FOR DP SUBMISSION GENERAL REVISIONS	ARDA	S	CALE	3179 VIA CENTRALE	PLOT DATE:
WATER X <sup>LS</sup> LAMP STANDARD JB UTILITY JUNCTION BOX NO. DATE	BYREVISIONNo.MM/DD/YYBY	REVISION	CONSULTANTS LTD		H=1:200 V=1:200	CROSS SECTIONS	




CROSS SECTION X7

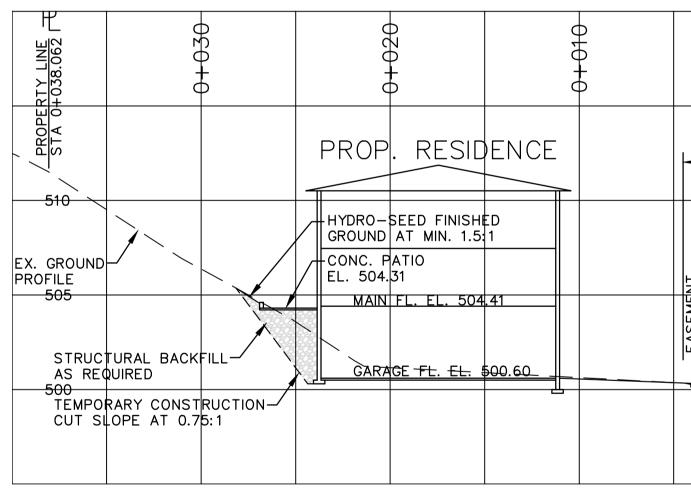

CROSS SECTION X6

	000+0	
	9.00m	
NT	STA 0+000 EXISTING ROAD CL	NT
 EASEMENT	EXISTING	EASEMENT

				515
-	9.0	0m		510
NT	STA 0+000	G ROAD CL	NT	
EASEMENT	STA 0+	EXISTING	EASEMENT	<del>505</del>
				500

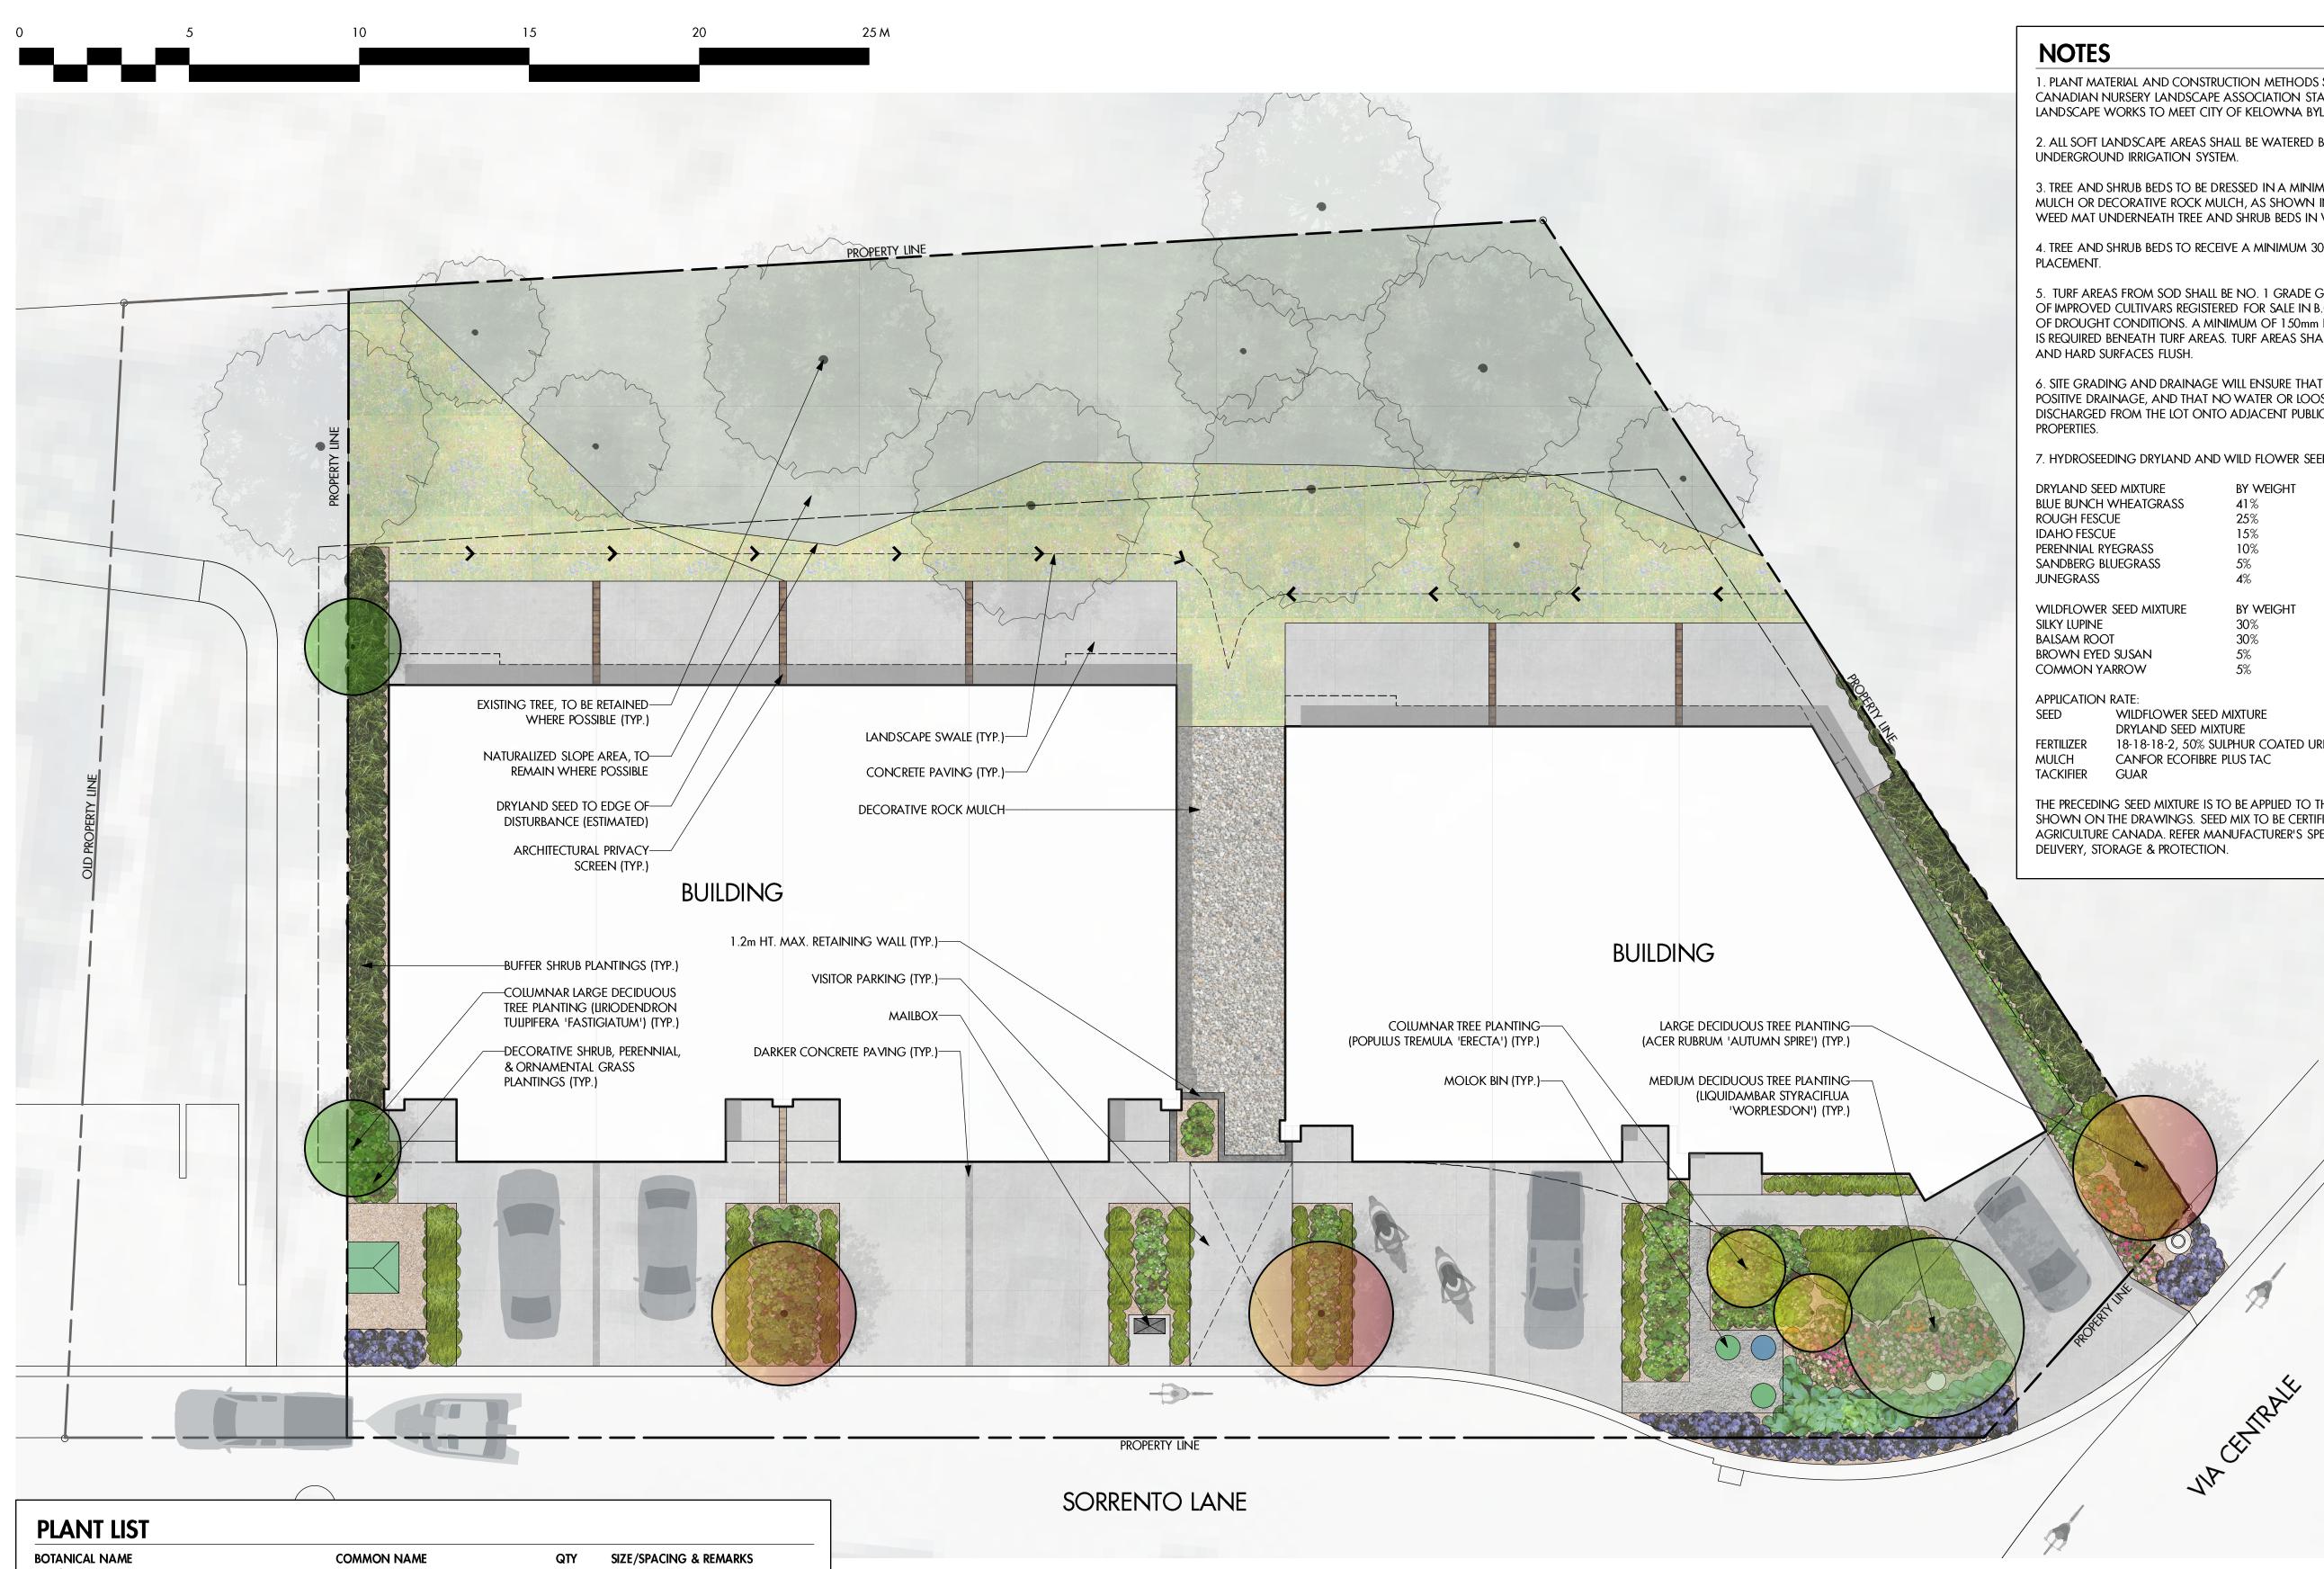

BOTANICAL NAME TREES	COMMON NAME	QTY	SIZE/SPACING & REMARKS
ACER RUBRUM 'AUTUMN SPIRE'	AUTUMN SPIRE RED MAPLE	3	5cm CAL.
LIQUIDAMBAR STYRACIFLUA 'WORPLESDON	WORPLESDON SWEETGUM	2	4cm CAL.
LIRIODENDRON TULIPIERA 'FASTIGIATUM'	COLUMNAR TULIP TREE	2	5cm CAL.
Populus tremula 'erecta'	COLUMNAR SWEDISH ASPEN	2	4cm CAL.
SHRUBS			
CORNUS SERICEA 'KELSEYI'	KELSEY DOGWOOD	12	#01 CONT. /1.2M O.C. SPACIN
EUONYMUS ALATUS 'SELECT'	DWARF BURNING BUSH	8	#01 CONT. /1.5M O.C. SPACIN
HYDRANGEA PANICULATA 'JAN'	LITTLE LIME HYDRANGEAA	12	#01 CONT. /1.2M O.C. SPACIN
PINUS ABIES 'NIDIFORMIS'	NEST SPRUCE	8	#01 CONT. /1.5M O.C. SPACIN
SPIREA BULMALDA 'ANTHONY WATERER'	ANTHONY WATERER SPIREA	12	#01 CONT. /1.2M O.C. SPACIN
SYRINGA MEYERI 'PALIBIN'	DWARF KOREAN LILAC	8	#01 CONT. /1.5M O.C. SPACIN
PERENNIALS, GRASSES & GROUNDCOVERS			
ARCTOSTAPHYLOS UVA-URSI	KINNICKINNICK	15	#01 CONT. /0.9M O.C. SPACIN
CALAMAGROSTIS ACUTIFLORA 'KARL FOERSTER'	Karl Foerster Reed Grass	15	#01 CONT. /0.9M O.C. SPACIN
ECHINACEA 'CHEYENNE SPIRIT'	CHEYENNE SPIRIT CONEFLOWER	15	#01 CONT. /0.9M O.C. SPACIN
PENNISETUM ALOPECUROIDES	FOUNTAIN GRASS	8	#01 CONT. /1.2M O.C. SPACIN
PEROVSKIA ATRIPLICIFOLIA	RUSSIAN SAGE	12	#01 CONT. /1.0M O.C. SPACIN

AUTUMN JOY STONECROP

SEDUM SPECTABILE 'AUTUMN JOY'

15 #01 CONT. /0.9M O.C. SPACING

1. PLANT MATERIAL AND CONSTRUCTION METHODS SHALL MEET OR EXCEED THE CANADIAN NURSERY LANDSCAPE ASSOCIATION STANDARDS. ALL OFFSITE LANDSCAPE WORKS TO MEET CITY OF KELOWNA BYLAW 7900 STANDARDS.

2. All soft landscape areas shall be watered by a fully automatic timed underground irrigation system.

3. TREE AND SHRUB BEDS TO BE DRESSED IN A MINIMUM 75mm BLACK WOOD MULCH OR DECORATIVE ROCK MULCH, AS SHOWN IN PLANS. DO NOT PLACE WEED MAT UNDERNEATH TREE AND SHRUB BEDS IN WOOD MULCH AREAS.

4. TREE AND SHRUB BEDS TO RECEIVE A MINIMUM 300mm DEPTH TOPSOIL

5. TURF AREAS FROM SOD SHALL BE NO. 1 GRADE GROWN FROM CERTIFIED SEED OF IMPROVED CULTIVARS REGISTERED FOR SALE IN B.C. AND SHALL BE TOLERANT OF DROUGHT CONDITIONS. A MINIMUM OF 150mm DEPTH OF GROWING MEDIUM IS REQUIRED BENEATH TURF AREAS. TURF AREAS SHALL MEET EXISTING GRADES

6. SITE GRADING AND DRAINAGE WILL ENSURE THAT ALL STRUCTURES HAVE POSITIVE DRAINAGE, AND THAT NO WATER OR LOOSE IMPEDIMENTS WILL BE DISCHARGED FROM THE LOT ONTO ADJACENT PUBLIC, COMMON, OR PRIVATE

7. HYDROSEEDING DRYLAND AND WILD FLOWER SEED AREAS

DRYLAND SEED MIXTURE BLUE BUNCH WHEATGRASS ROUGH FESCUE IDAHO FESCUE PERENNIAL RYEGRASS	BY WEIGHT 41% 25% 15% 10%	BY SPECIES 23% 20% 1 <i>9</i> % 7%
SANDBERG BLUEGRASS	5%	13%
JUNEGRASS	4%	18%
WILDFLOWER SEED MIXTURE SILKY LUPINE BALSAM ROOT	By Weight 30% 30%	
	JU /0	

SEED	WILDFLOWER SEED MIXTURE	1 kg/hectare			
	Dryland seed mixture	50 KG/HECTARE			
FERTILIZER	18-18-18-2, 50% SULPHUR COATED UREA	400 KG/HECTARE			
MULCH	CANFOR ECOFIBRE PLUS TAC	2,800 KG/HECTARE			
TACKIFIER	GUAR	3% OF MIX			

The preceding seed mixture is to be applied to the dryland seed areas shown on the drawings. Seed mix to be certified #1 grade by AGRICULTURE CANADA. REFER MANUFACTURER'S SPECIFICATIONS FOR PRODUCT





### PROJECT TITLE

## 3179 VIA CENTRALE

### Kelowna, BC

DRAWING TITLE

### CONCEPTUAL LANDSCAPE PLAN

### ISSUED FOR / REVISION

.000					
1	21.12.20	Issued for Development Permit			
2	21.12.22	Issued for Development Permit			
3	23.05.31	Issued for Development Permit			
4					
5					

PROJECT NO	21-097
design by	FB
dravvn by	NG
CHECKED BY	FB
DATE	MAY 31, 2023
SCALE	1:100
PAGE SIZE	24x36"


SEAL



DRAWING NUMBER

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## **IRRIGATION NOTES**

1. IRRIGATION PRODUCTS AND INSTALLATION METHODS SHALL MEET OR EXCEED THE REQUIREMENTS OF THE WATER USE REGULATION BYLAW NO. 10480 AND THE SUPPLEMENTARY SPECIFICATIONS IN THE CITY OF KELOWNA BYLAW 7900 (PART 6, SCHEDULE 5).

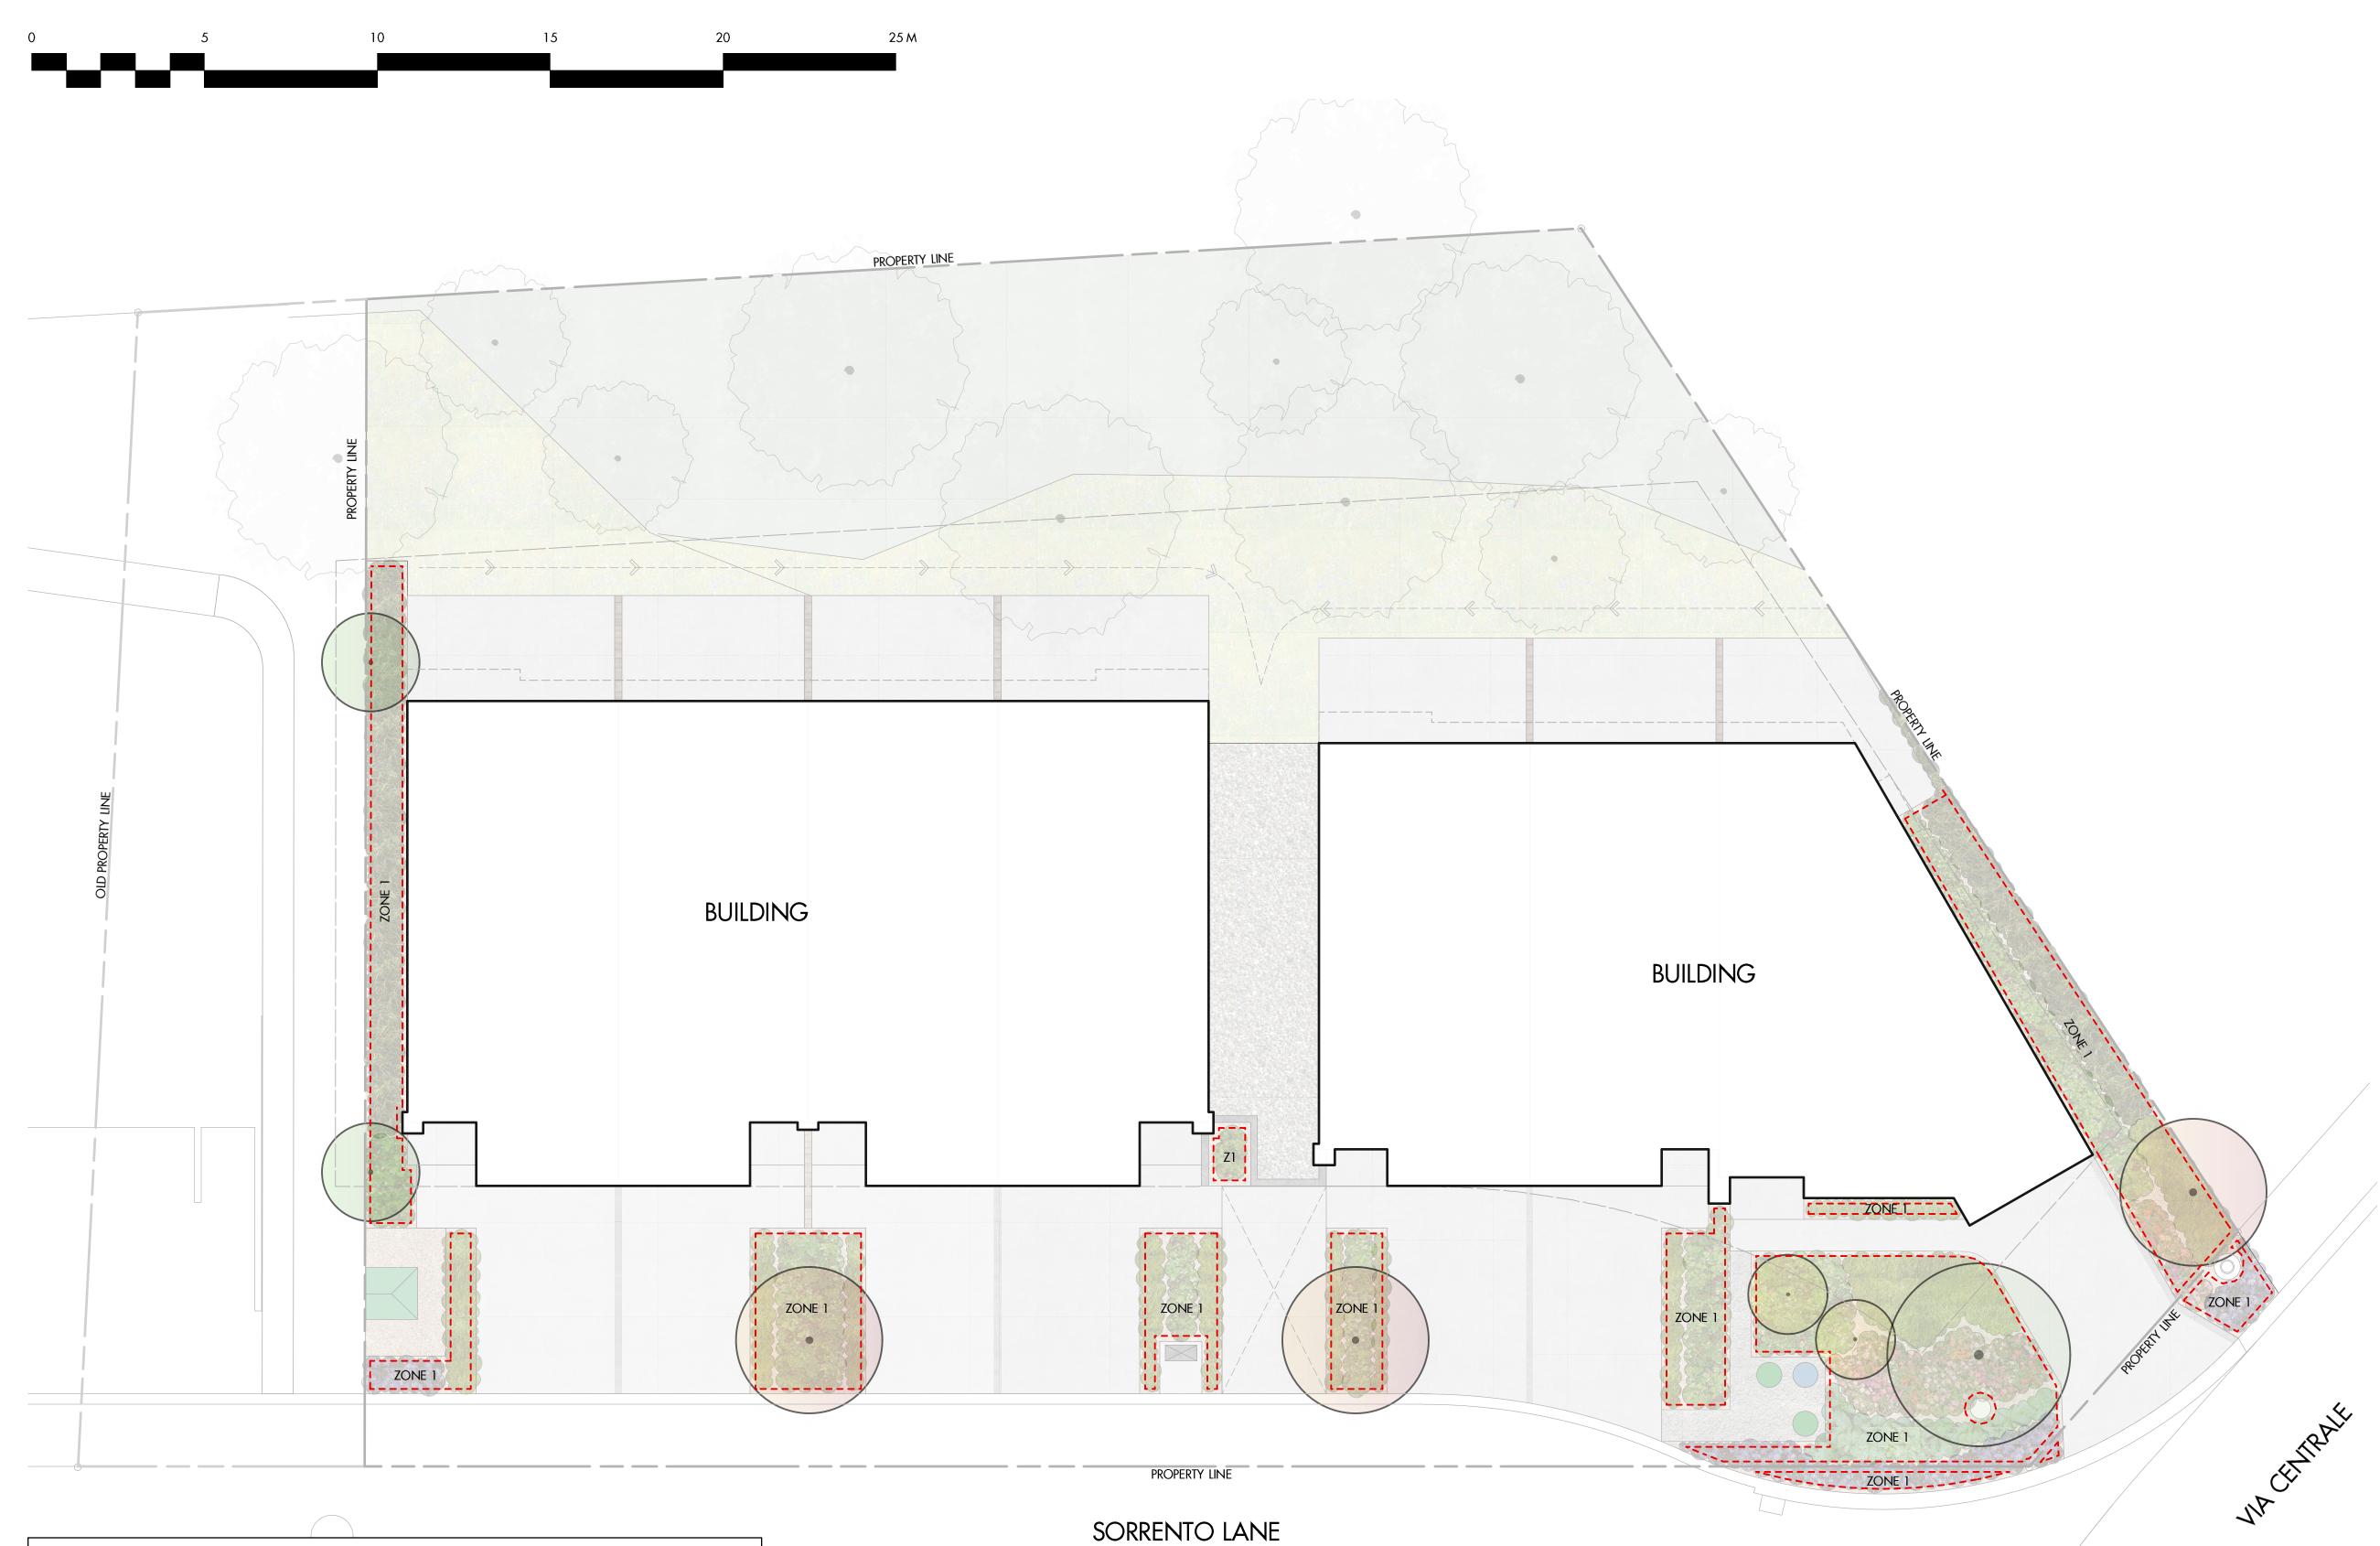2. THE IRRIGATION SYSTEM SHALL MEET THE REQUIREMENTS, REGULATIONS, AND BYLAWS OF THE WATER PURVEYOR.

3. THE IRRIGATION SYSTEM SHALL BE EQUIPPED WITH AN APPROVED BACKFLOW PREVENTION DEVICE, WATER METER, AND SHUT OFF VALVE LOCATED OUTSIDE THE BUILDING ACCESSIBLE TO THE CITY.

4. AN APPROVED SMART CONTROLLER SHALL BE INSTALLED. THE IRRIGATION SCHEDULING TIMES SHALL UTILIZE A MAXIMUM ET VALUE OF 7" / MONTH (KELOWNA JULY ET), TAKING INTO CONSIDERATION SOIL TYPE, SLOPE, AND MICROCLIMATE.


5. DRIP LINE AND EMITTERS SHALL INCORPORATE TECHNOLOGY TO LIMIT ROOT INTRUSION.

6. IRRIGATION SLEEVES SHALL BE INSTALLED TO ROUTE IRRIGATION LINES UNDER HARD SURFACES AND FEATURES.

7. IRRIGATION PIPE SHALL BE SIZED TO ALLOW FOR A MAXIMUM FLOW OF 1.5m /SEC.

8. A FLOW SENSOR AND MASTER VALVE SHALL BE CONNECTED TO THE CONTROLLER AND PROGRAMMED TO STOP FLOW TO THE SYSTEM IN CASE OF AN IRRIGATION WATER LEAK.

## **IRRIGATION LEGEND**

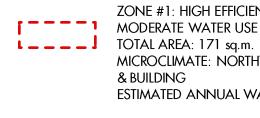

ZONE #1: HIGH EFFICIENCY SUBSURFACE DRIP IRRIGATION FOR MODERATE WATER USE PLANTING AREAS

> MICROCLIMATE: NORTHWEST EXPOSURE, PARTIALLY SHADED BY TREES & BUILDING

ESTIMATED ANNUAL WATER USE: 57 cu.m.

## WATER CONSERVATION CALCULATIONS

LANDSCAPE MAXIMUM WATER BUDGET (WB) = 368 cu.m. / year ESTIMATED LANDSCAPE WATER USE (WU) = 57 cu.m. / year WATER BALANCE = 311 cu.m. / year \*REFER ATTACHED IRRIGATION APPLICATION FOR DETAILED CALCULATIONS



PROJECT TITLE

## 3179 VIA CENTRALE

### Kelowna, BC

DRAWING TITLE

## WATER CONSERVATION/ **IRRIGATION PLAN**

### ISSUED FOR / REVISION

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21-097 FB NG FB
NG
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MAY 31, 2023
1:100
24x36"

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